
SITE PLAN 311 EAST EDSALL BOULEVARD

11 UNIT TOWNHOUSE RESIDENCE BOROUGH OF PALISADES PARK, BERGEN COUNTY, N.J.

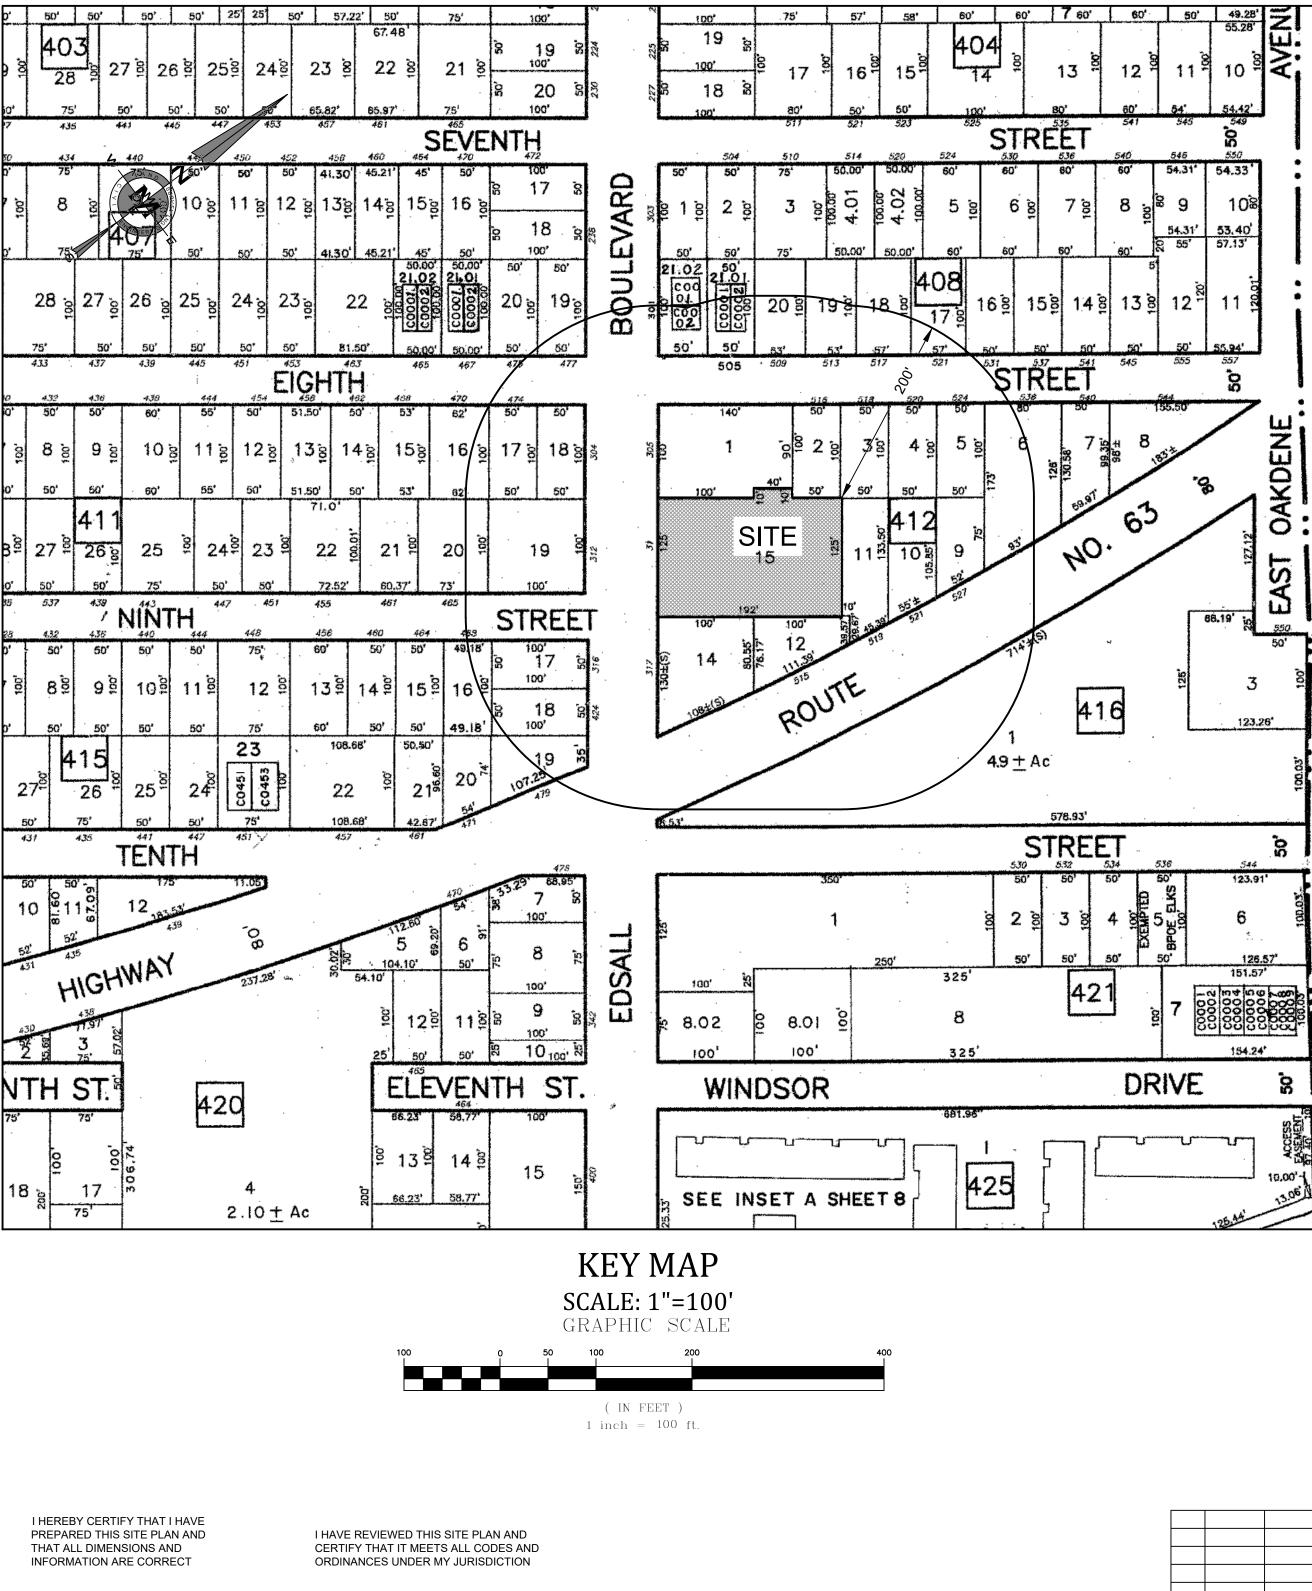

PROPERTY OWNERS WITHIN 200 FEET

Block	Lot	Owner's Name
00407	00019	AVELLA, EUGENE
00407	00020	DIMATOS, LEONIDAS D.
00408	00016	MAVER, MARTIN L & DOROTHY A
00408	00017	MILLER, GEORGE G.& CAROL
00408	00018	ALEXIS, DAVID & SUNG JU
00408	00019	VELTRI, GISELLE
00408	00020	HAROUTIOUNIAN(RES TRUST),
00408	00021	A.D.G. CONSTRUCTION CORP.
00408	00021 01	A.D.G. CONSTRUCTION CORP.
00408	00021 01 C000A	DOMENICUCCI, STEFANO
00408	00021 01 C000B	PL JAE H
00408	00021 02	A.D.G. CONSTRUCTION CORP.
00408	00021 02 C000A	LEE, JAESEUNG
00408	00021 02 C000B	GRACE-BETHEL UNIT METHODIST
00411	00016	PDC LLC
00411	00016 C0001	BROGNA, STEVEN & ADAMO, AMAND
00411	00016 C0002	HWANG, CHONG SUN & PETER WOO
00411	00017	KUSAKSIZYAN, EDVARD
00411	00018	CONLON, THOMAS J & MYONG C
00411	00019	ALLIOTTS CONST.
00411	00019 01	312 EDSALL LLC
00411	00019 02	312 EDSALL LLC
00411	00020	GENCO ENTERPRISES LLC
00411	00020 C0001	YANG, SHI CHEN & JAN WEI JUNG

	Property
h - en l'Altrata andre et altra	477 8TH S
).	475 8TH S
DROTHY A	531 8TH S
CAROL	521 8TH S
S JU	517 8TH S
	513 8TH S
TRUST),	509 8TH S
N CORP.	505 8TH S
I CORP.	505 8TH S
NO	505A 8TH
1	505B 8TH
N CORP.	301 E. ED
	301A E. EI
METHODIST	301B E. EI
	470 8TH S
damo, amanda	470A 8TH
& PETER WOON	470B 8TH
D	474 8TH S
MYONG C	304 E EDS
	312 E EDS
	469 9TH S
	467 9TH S
LLĊ	465 9TH S

STREET STREET SALL BLVD **DSALL BLVD** DSALL BLVD STREET STREET SALL BL ALL BL TREET STREET 465A 9TH STREET

Mailing Adddress 536 8TH ST PALISADES PARK, NJ 07650 475 8TH ST PALISADES PARK NJ 07650 197 LAFAYETTE AVENUE WESTWOOD, NJ 0767 521 8TH ST PALISADES PARK NJ 0765 17 8TH ST PALISADES PARK, NJ 07650 3 8TH STREET PALISADES PARK, NJ 0765 5B 8TH ST PALISADES PARK, NJ 07650 103 3RD AVENUE NORTH BERGEN, N.J. 07047 301A E EDSALL BLVD PALISADES PARK, NJ 07650 396 BROAD AVE LEONIA, NJ 07605 1 CRESCENT AVENUE CLIFFSIDE PARK, NJ 07010 0 8TH STREET UNIT A PALISADES PARK, NJ 07650 4 EIGHTH ST PALISADES PARK, NJ 07650 304 EAST EDSELL BLVD PALISADES PARK, NJ 07650 LOITTS PL PALISADES PARK, NJ 07650 1 ALLIOTTS PLACE PALISADES PARK, NJ 07650 1 ALLIOTTS PLACE PALISADES PARK, NJ 07650 465 9TH ST PALISADES PARK, NJ 07650 465A 9TH STREET PALISADES PARK, NJ 07650

UTILITIES & PUBLIC AGENCIES:

NEW JERSEY BELL/VERIZON RICHARD D. YOUNG III

SUEZ WATER NEW JERSEY C/O CORPORATE SECRETARY

PUBLIC SERVICE ELECTRIC & GAS CO. C/O CORPORATE SECRETARY

BERGEN COUNTY UTILITIES AUTHORITY CHIEF ENGINEER/ DIRECTOR OF WPC DIV.

CABLEVISION GENERAL MANAGER

BERGEN COUNTY PLANNING BOARD C/O DIVISION OF PLANNING AND ENGINEERING

I HEREBY CERTIFY THAT ALL REQUIRED IMPROVEMENTS HAVE BEEN INSTALLED OR THAT A PERFORMANCE GUARANTEE HAS BEEN POSTED IN ACCORDANCE WITH SECTION ____OF THE SITE PLAN ORDINANCE

DATE BUILDING SUBCODE OFFICIAL

BOROUGH ENGINEER

I HEREBY CERTIFY THAT ALL THE REQUIRED IMPROVEMENTS OF THIS SITE PLAN HAVE BEEN INSTALLED IN COMPLIANCE WITH ALL APPLICABLE CODES AND ORDINANCES.

540 BROAD ST, ROOM 2001

HACKENSACK, NJ 07601

LITTLE FERRY, NJ 07643

ONE BERGEN COUNTY PLAZA-4TH FL

NEWARK, NJ 07101

69 DEVOE PLACE

80 PARK PLAZA

MAIL CODE T5E

PO BOX 122

NEWARK, NJ 07101

40 POTASH ROAD

OAKLAND, NJ 07436

HACKENSACK, NJ 07601

DATE BUILDING SUBCODE OFFICIAL

BOROUGH ENGINEER OCCUPANCY PERMIT ISSUED DATE:

DATE APPLICANT

I CONSENT TO THE FILING OF THIS SITE PLAN

ADJUSTMENT) OF THE BOROUGH OF PALISADES PARK

WITH THE PLANNING BOARD (BOARD OF

DATE MARK S. MARTINS, PE & LS N.J. LIC. NO. 35,858

DATE BOROUGH ENGINEER


DRAWING SCHEDULE

SHEET TITLE

- COVER SHEET
- **BOUNDARY & TOPOGRAPHIC SURVEY**
- SITE PLAN
- **GRADING & UTILITIES PLAN**
- LANDSCAPE PLAN
- LIGHTING PLAN
- SOIL EROSION CONTROL PLAN
- CONSTRUCTION DETAILS

Applicant: V&R Developers

		COVER SHEET			
	Mark Martins Engineering, LLC 55 WALNUT ST., SUITE 201 · NORWOOD, NJ · 07648 TEL 201-391-3222 · FAX 201-215-2210 Certificate of Authorization #24GA28265200	311 EAST EDSALL BLVD LOT 15 & BLOCK 412 Situated in the Borough of Palisades Park Bergen County, NJ			
	MARK S. MARTINS Professional Engineer & Land Surveyor New Jersey License No. 35,858				
		SCALE: 1" = 20'	DRAWN:SF	CHECK'D:MM	SHEET
Y	Member Mark Martins Engineering, LLC	DATE: 12-04-20	FILE NO	. 20-2812	1 OF 8

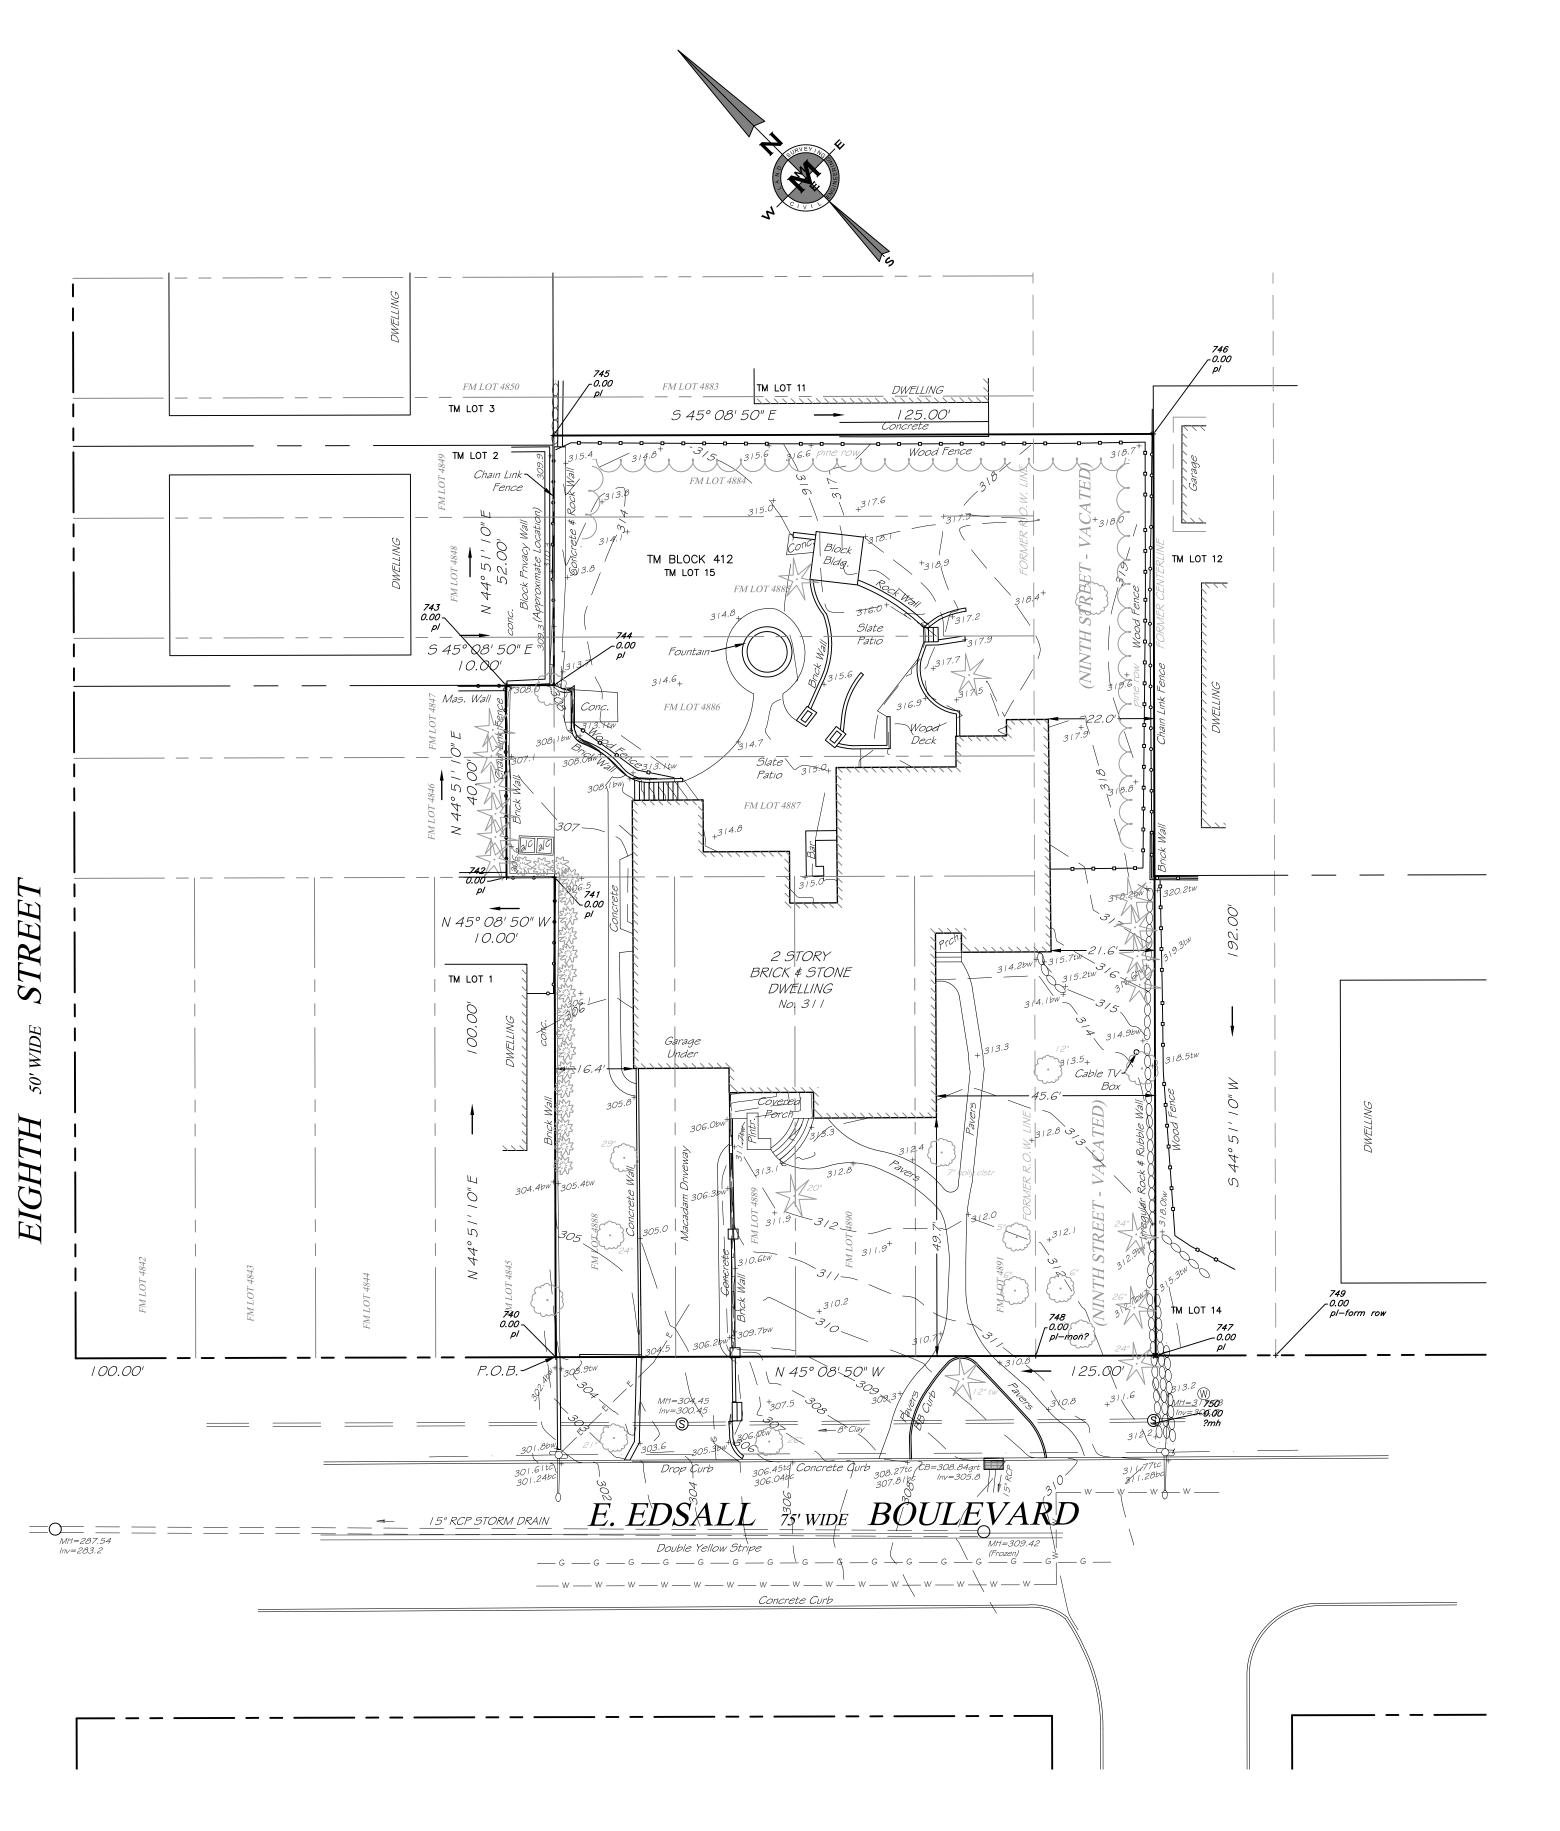

STREE EIGHTH

NO.	DATE	DESC RIPTION

REFERENCES:

- 1. LOTS 4885, 4886, 4887, 4888, 4889, 4890 & 4891 AND PART OF LOTS 4884, 4846 & 4847, ALONG WITH THE WESTERLY 25' OF NINTH STREET (NOW VACATED) ALONG THE FRONTAGE OF LOTS 4884, 4885, 4886, 4887 & 4891, AS SHOWN ON A CERTAIN MAP ENTITLED "SECOND MAP OF PROPERTY OF EDSALL BROS. AT PALISADES PARK, BERGEN CO., N.J." FILED IN THE BERGEN COUNTY CLERK'S OFFICE ON APRIL 12, 1895, AS MAP NO. 469.
- 2. ALSO KNOWN AS LOT 15 IN BLOCK 415 AS SHOWN ON THE TAX MAP OF THE BOROUGH OF PALISADES PARK.

GENERAL NOTES:


- 1. VERTICAL DATUM NGVD 29.
- 2. AREA OF TRACT = 24,400 +/- SF (0.56 +/- AC)
- 3. A WRITTEN "WAIVER AND DIRECTION NOT TO SET PROPERTY CORNER MARKERS" HAS BEEN OBTAINED FROM THE ULTIMATE USER PURSUANT TO N.J.A.C. 13:40-5.1(D).
- 4. EXCEPT AS SPECIFICALLY STATED OR SHOWN ON THIS PLAT, THIS SURVEY DOES NOT PURPORT TO REFLECT ANY OF THE FOLLOWING WHICH MAY BE APPLICABLE TO THE SUBJECT PROPERTY: EASEMENTS, UNDERGROUND UTILITIES, BUILDING SETBACK LINES, RESTRICTIVE COVENANTS, SUBDIVISION RESTRICTIONS, ZONING OR OTHER LAND-USE REGULATIONS, WETLANDS, ENVIRONMENTAL CONDITIONS OR CONTAMINATION, TREES, AND ANY OTHER FACTS THAT AN ACCURATE AND CURRENT TITLE SEARCH MAY DISCLOSE.
- 5. OFFSETS SHOWN HEREON ARE NOT TO BE USED AS A BASIS FOR CONSTRUCTION.

6. SUBJECT TO RESTRICTIONS AND EASEMENTS OF RECORD, IF ANY.

	20 0 10 20 	C SCALE 40 FEET) = 20 ft.		80	
		BOUNDAR	Y & TOF	POGRAP	HIC SURVEY
		311 E	EAST E	EDSALI	BLVD
	MARK MARTINS ENGINEERING, LLC	LOT	15 &	BLOCH	K 412
	TEL 201-391-3222 · FAX 201-215-2210 CERTIFICATE OF AUTHORIZATION #24GA28265200	Dor		ed in the	Dark
	MARK S. MARTINS Professional Engineer & Land Surveyor New Jersey License No. 35,858	BOI	0	Palisades County, N	
		SCALE: 1" = 20'	DRAWN:SF	CHECK'D:MM	SHEET
BY	Member Mark Martins Engineering, LLC	DATE: 12-04-20	FILE NO	. 20-2812	2 OF 8

			-		
					<u>S</u>
	BUILDING COVERAG	<u>GE COMPUTATIONS</u>			ONITIEMA
	PROPOSED BUILDING 1 PROPOSED BUILDING 2	= 4278.8 sf = 5320.0			
	COVERED PORCHES TOTAL BUILDING AREA	<u>= 107.9</u> = 9706.7 sf			
	BUILDING COVERAGE	= 9706.7 / 24,400 = 39.78%	 - 		
					PROPOSED TR/ ENCLOSURE
	BUILDING HEIGHT C	ALCULATIONS			EXISTING WALL T CONDITION TO BE BY A STRUCTURA
	BUILDING No. 1:				REPAIR OR REPL NECESSARY.
	PROPOSED GRADE PLA	NE			
	= (309.9+305.0+306.5+31 = 310.87	4.8+316.4+312.6) / 6	l		
	MEAN ROOF ELEV (HIGH				PROPOSED 6' H PVC FENCE (TY
	MEAN ROOF ELEV (LOW BUILDING HEIGHT = 347	EST) = 343.67 67 - 310.87 = 36.80' (HIGHEST)			
		33 - 310.87 = 31.46' (LOWEST)	 		EXISTING BUILD
	PROPOSED GRADE PLA	NE			AND STRUCTUF TO BE REMOVE (TYP)
	= (312.0+309.9+312.6+31				
	= 314.23		STREET		
	MEAN ROOF ELEV (HIGH MEAN ROOF ELEV (LOW		STI		PAVER WALK (T
		00 - 314.23 = 36.77' (HIGHEST) 33 - 314.23 = 30.10' (LOWEST)	I DE		PLANTER (TYP.
			50' WIDE		LINE OF FLOOR
					(TYP.)
	RSIS PARKING CALC	ULATIONS	HTH 		
	3 BEDROOM UNITS = 2. 11 UNITS x 2.4 SPS/UNI		\mathbf{S}		
			EI		
	VISITOR PARKING: REQ'D = 0.5 SP/UNIT x 1				PROPOSED CONC
	(LOCATED IN A COMMC	N AREA)			
			L	100.00'	PROPOSED STO SIGN R1-1
				=	
LEGEND					
ا	JTILITY POLE LIGHT POLE				
	TRAFFIC SIGNAL POLE JUNCTION BOX			287.54 283.2	=
 - 5	SIGN				
740	FIRE HYDRANT SANITARY MANHOLE				
-	DRAINAGE MANHOLE CATCH BASIN				
000 — — E	EXISTING CONTOUR				
	PROPOSED CONTOUR EXISTING GRADE				
]		
	TOP OF CURB BOTTOM OF CURB				
TW	TOP OF WALL		I		
	BOTTOM OF WALL				
BS E	BOTTOM OF SLOPE				
	MANHOLE CATCH BASIN				
LI L	AWN INLET				
	NVERT ELEVATION FINISHED FLOOR ELEVATION				
	RON PIPE OR PIN RE-BAR				
MON	MONUMENT				
2.5	BENCHMARK				

EXISTING TREE TO BE REMOVED

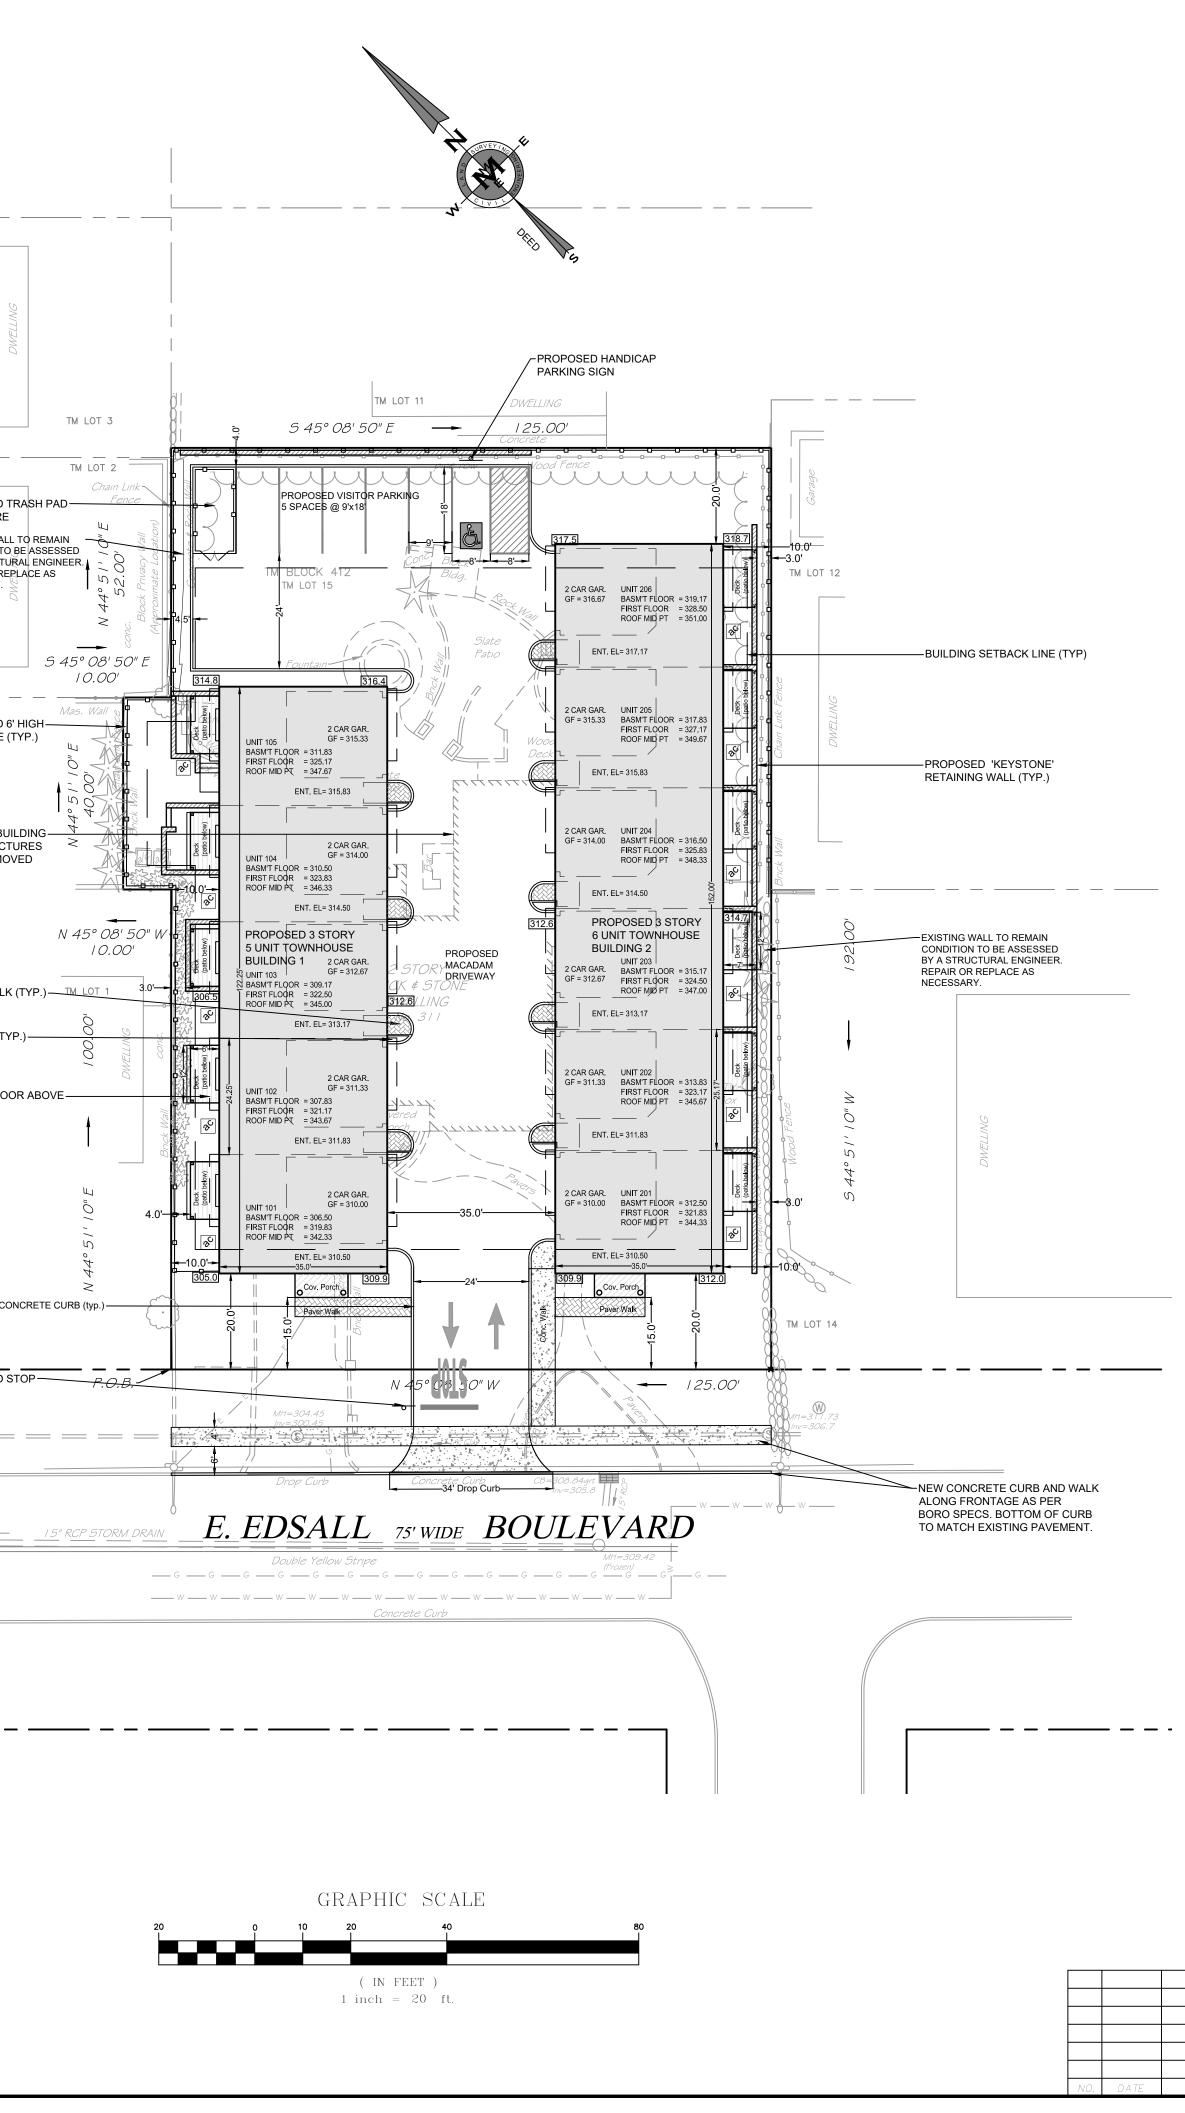

ZONING SCHEDULE

ZONE AA ONE & TWO FAMILY RESIDENTIAL

ITEM	REQ'D	PROPOSED	VAR.
USE	1 & 2 FAMILY	11 UNITS	YES
MIN. LOT AREA (S.F)	5,000	24,400	NO
MIN. LOT WIDTH (FT.)	50	125	NO
NUMBER OF BUILDINGS	1	2	YES
MIN. FRONT YARD (FT.)	25	20	YES
MIN. FRONT YARD -PORCH (FT.)	21	15	YES
MIN. REAR YARD (FT.)	25	20.0	YES
MIN. SIDE YARD (FT.) - ONE	5	10.0 / 10.0	NO
- BOTH	14	20.0	NO
MIN. SIDE YARD - DECK - BLDG #1 (FT.)	3	4.0	NO
MIN. SIDE YARD - DECK - BLDG #2 (FT.)	3	3.0	NO
MIN. SIDE YARD - PATIO - BLDG #1 (FT.)	3	3.0	NO
MIN. SIDE YARD - PATIO - BLDG #2 (FT.)	3	3.0	NO
MAX. LOT COVERAGE (%)	40	39.78	NO
MAX. BLDG HEIGHT- BLDG#1 (STY./FT.)	2 1/2 / 25	3 / 36.80	YES
MAX. BLDG HEIGHT- BLDG#2 (STY./FT.)	2 1/2 / 25	3 / 36.77	YES
PARKING (RSIS)	2.4sp/unit x 11=26	28	NO
GUEST PARKING (RSIS)	0.5sp/unit x 11= 5	6	NO

WAIVERS REQUESTED FOR PARKING STALL SIZE:

	REQUIRED
PARKING STALL DIMENSION	9' x 20'
PARKING STALL AREA	180 sf

PROPOSED 9' x 18' 162 sf

NOTES:


- 1. BOUNDARY AND TOPOGRAPHIC INFORMATION AS PER SURVEY PREPARED BY THIS OFFICE DATED OCTOBER 5, 2020. VERTICAL ELEVATIONS BASED ON NGVD DATUM.
- 2. PROPERTY DESCRIPTION: 311 EAST EDSALL BLVD LOT 15 BLOCK 412

TAX MAP SHEET 4

- 3. ALL CONSTRUCTION WORK MUST BE PERFORMED IN ACCORDANCE WITH ALL APPLICABLE RULES AND REGULATIONS OF THE OCCUPATIONAL SAFETY AND HEALTH ADMINISTRATION (OSHA), THE NEW JERSEY UNIFORM CONSTRUCTION CODE, FEDERAL, STATE, AND LOCAL REQUIREMENTS, MANUFACTURER'S INSTALLATION REQUIREMENTS AND PROCEDURES, AND GOOD CONSTRUCTION AND ENGINEERING PRACTICE AS PERTAINS TO SAFETY.
- 4. CURBS, DRIVEWAYS, SIDEWALKS AND STORM SEWERS SHALL BE CONSTRUCTED TO BOROUGH SPECIFICATIONS.
- 5. ANY ADJACENT STRUCTURES, RETAINING WALLS, LANDSCAPING, CURBS, PIPING, PAVEMENT, FENCES, ETC. DAMAGED DURING CONSTRUCTION MUST BE REPAIRED OR REPLACED.
- 6. THERE ARE NO COVENANTS, DEED RESTRICTIONS, EASEMENTS OR EXCEPTIONS KNOWN TO AFFECT THE SITE EXCEPT AS SHOWN.
- 7. PRIOR TO CONSTRUCTION, CONTRACTOR SHALL VERIFY THE LOCATION AND DEPTHS OF ALL UTILITIES AND SHALL IMMEDIATELY NOTIFY THE ENGINEER OF ANY CONFLICTS WITH THIS PLAN.
- 8. EXISTING IMPERVIOUS AREA = 8,990 sf = 36.8% PROPOSED IMPERVIOUS AREA = 3,054.7 sf = 61.09% NET INCREASE IN IMPERVIOUS AREA = sf
- 9. REFER TO ARCHITECTURAL PLANS PREPARED BY VIRGONA & VIRGONA FOR FLOOR PLANS, ELEVATIONS AND ADDITIONAL INFORMATION.

		SITE PLAN			
	ARK S. MARTINS	LOT	C 15 & Situat cough of	BLOCH ed in the Palisades	Park
	Professional Engineer & Land Surveyor New Jersey License No. 35,858		Bergen	County, N	IJ
		SCALE: 1" = 20'	DRAWN:SF	CHECK'D:MM	SHEET
BY	Member Mark Martins Engineering, LLC	DATE: 12-04-20	FILE NC). 20-2812	3 OF 8

LEGEND		
ъ	UTILITY POLE	
¢	LIGHT POLE	
•	TRAFFIC SIGNAL POLE	
×	JUNCTION BOX	
	SIGN	
¥	FIRE HYDRANT	
S	SANITARY MANHOLE	
Ø	DRAINAGE MANHOLE	
	CATCH BASIN	
000 — —	EXISTING CONTOUR	
000	PROPOSED CONTOUR	
00.00	EXISTING GRADE	
00.00 PRO	POSED GRADE	
TC	TOP OF CURB	
BC	BOTTOM OF CURB	
TW	TOP OF WALL	
BW	BOTTOM OF WALL	
TS	TOP OF SLOPE	
BS	BOTTOM OF SLOPE	
МН	MANHOLE	
СВ	CATCH BASIN	
LI	LAWN INLET	
INV	INVERT ELEVATION	
FF	FINISHED FLOOR ELEVATION	
IP	IRON PIPE OR PIN	
RB	RE-BAR	
MON	MONUMENT	
BM	BENCHMARK	
2	EXISTING TREE	
	EXISTING TREE TO BE REMOVED	

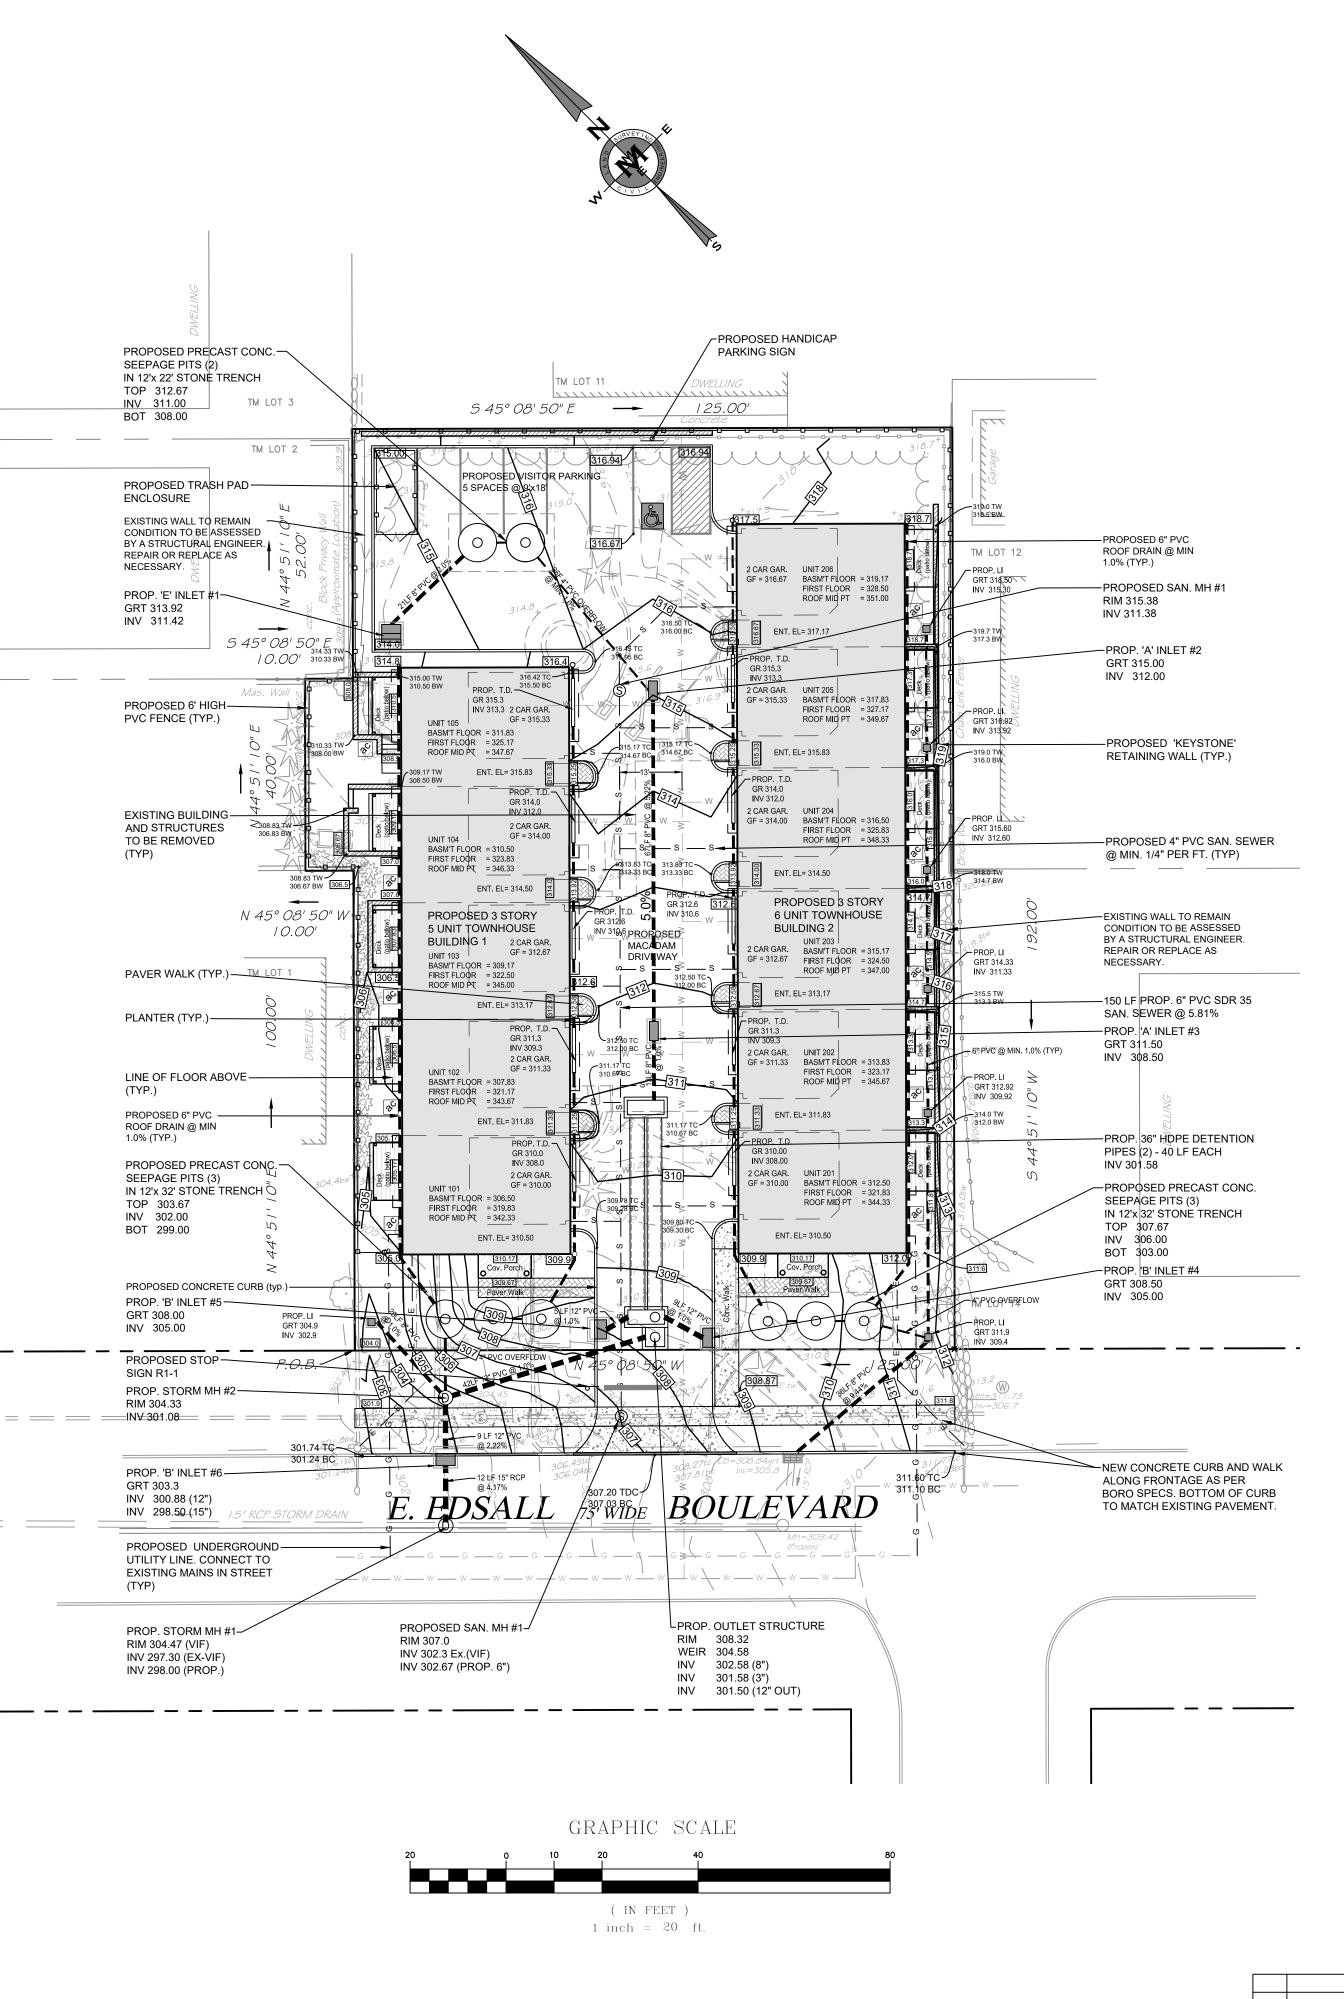

ENCLOSURE

NECESSARY.

GRT 313.92 INV 311.42

(TYP)

(TYP.)

GRT 308.00

SIGN R1-1 RIM 304.33

GRT 303.3

(TYP)

NOTES:

- 1. ALL CONSTRUCTION WORK MUST BE PERFORMED IN ACCORDANCE WITH ALL APPLICABLE RULES AND REGULATIONS OF THE OCCUPATIONAL SAFETY AND HEALTH ADMINISTRATION (OSHA), THE NEW JERSEY UNIFORM CONSTRUCTION CODE, FEDERAL, STATE, AND LOCAL REQUIREMENTS, MANUFACTURER'S INSTALLATION REQUIREMENTS AND PROCEDURES, AND GOOD CONSTRUCTION AND ENGINEERING PRACTICE AS PERTAINS TO SAFETY.
- 2. PRIOR TO CONSTRUCTION, CONTRACTOR SHALL VERIFY THE LOCATION AND DEPTHS OF ALL UTILITIES AND SHALL IMMEDIATELY NOTIFY THE ENGINEER OF ANY CONFLICTS WITH THIS PLAN.
- 3. ALL PUBLIC SIDEWALKS SHALL BE ADA COMPLIANT.
- 4. CURBS, DRIVEWAYS, SIDEWALKS AND STORM SEWERS SHALL BE CONSTRUCTED TO BOROUGH SPECIFICATIONS.
- 5. THE APPLICANT SHALL RESTORE ANY ROADWAY EXCAVATED EITHER BY MILL/REPAVE OR INFRARED REPAIR METHODS.
- 6. ANY ADJACENT STRUCTURES, RETAINING WALLS, LANDSCAPING, CURBS, PIPING, PAVEMENT, FENCES, ETC. DAMAGED DURING CONSTRUCTION MUST BE REPAIRED OR REPLACED. ANY ROADWAY, CURBING, OR STORM INLETS ALONG THE PROPERTY FRONTAGE DAMAGED DUE TO CONSTRUCTION ACTIVITIES SHALL BE REPAIRED BY THE APPLICANT TO THE SATISFACTION OF THE BOROUGH'S CONSTRUCTION AND/OR ENGINEERING DEPARTMENTS.
- 7. THE APPLICANT SHALL BE RESPONSIBLE FOR THE REPAIR AND RECONSTRUCTION OF PAVEMENT, CURB, SIDEWALK, OR OTHER PUBLIC PROPERTY DAMAGED DURING CONSTRUCTION.
- 8. ALL ROOF LEADERS SHALL BE CONNECTED INTO THE PROPOSED DRAINAGE SYSTEM. ALL PVC PIPING TO BE MIN. SCH. 40. LEAF GUARDS OR SCREENS SHALL BE PROVIDED FOR ALL GUTTERS TO PREVENT LEAFS AND DEBRIS FROM ENTERING THE DRAINAGE SYSTEM.
- 9. PRIOR TO THE ORDERING OF MATERIALS AND THE INSTALLATION OF THE RETENTION SYSTEM, THE APPLICANT SHALL BE RESPONSIBLE FOR OBTAINING THE SEASONAL HIGH WATER TABLE (SHWT) AND SOIL INFILTRATION RESULTS TO SUPPORT THE PROPOSED SYSTEM DESIGN. THE APPLICANT SHALL PROVIDE THE RESULT TO THE BOROUGH ENGINEER FOR REVIEW AND APPROVAL. IF SOILS ARE UNFAVORABLE, THE APPLICANT IS RESPONSIBLE FOR SUBMITTING REVISED PLANS.
- 10. THE DRAINAGE SYSTEM SHALL BE MAINTAINED ON A PERIODIC BASIS, AT A MINIMUM, THE RETENTION CHAMBERS ARE TO BE INSPECTED TWICE A YEAR OR AFTER RAINFALL EVENTS GREATER THAN 2". DEBRIS AND OBSTRUCTIONS SHALL BE CLEARED AND ALL NECESSARY REPAIRS MADE. OPERATION, MAINTENANCE AND REPAIRS ARE THE RESPONSIBILITY OF THE PROPERTY OWNER AND SHALL TRANSFER TO ANY FUTURE PROPERTY OWNERS AND SHALL BE MADE IN ACCORDANCE WITHIN THE GUIDELINES ESTABLISHED WITHIN THE NEW JERSEY STORM WATER BEST MANAGEMENT PRACTICES (BMP) MANUAL.

11. THERE SHALL BE NO DIRECT SUMP PUMP DISCHARGE TO THE STREET.

- 12. THE EXISTING SANITARY LATERAL IS NOT PERMITTED TO BE RE-USED. 13.LOCATION, DEPTH, MATERIAL, AND SIZE OF PROPOSED UTILITY CONNECTIONS TO BE COORDINATED WITH APPLICABLE UTILITY COMPANIES, ARCHITECT AND/OR MECHANICAL ENGINEER. ELECTRIC AND
- TELECOM LINES TO BE INSTALLED UNDERGROUND IF PERMITTED BY THE ELECTRICAL UTILITY. 14. CONTRACTOR SHALL GRADE THE SITE IN SUCH A MANNER SO AS TO DIRECT OVERLAND STORM-WATER RUNOFF AWAY FROM ADJOINING PROPERTIES.
- 15. ALL DISTURBED WORK AREAS SHALL BE STABILIZED WITH TOPSOIL, SEED, HAY, AND STRAW MULCH TO ENSURE LAWN GROWTH.
- 16. THE OPERATIONS OF SOIL MOVEMENT VEHICLES ARE NOT TO BE UTILIZED IN A WAY THAT WOULD DEPOSIT SOIL ON ANY STREET, SIDEWALK, PUBLIC PLACE, OR WITHIN ANY OTHER PRIVATE PROPERTY. ANY SOIL TRACKED ONTO THE STREET MUST BE IMMEDIATELY REMOVED. IF TRACKED SOIL REMAINS OVERNIGHT, THE DPW SHALL REMOVE IT AND ASSESS THE APPLICANT FOR THOSE COSTS.
- 17. THE APPLICANT SHALL BE RESPONSIBLE FOR ENSURING THAT ANY AND ALL SOILS IMPORTED TO THE SITE ARE CERTIFIED CLEAN SOILS IN ACCORDANCE WITH CURRENT NJDEP STANDARDS. RECYCLED MATERIAL OR DEMOLISHED MATERIALS ARE NOT PERMITTED FOR THE PURPOSES OF BACKFILLING A VACATED EXCAVATION AREA.
- 18. ALL RETAINING WALLS IN EXCESS OF FOUR FEET (EXPOSED HEIGHT) IN HEIGHT REQUIRE WALL STABILITY CALCULATIONS. UPON COMPLETION OF CONSTRUCTION, ALL RETAINING WALLS IN EXCESS OF FOUR FEET (EXPOSED HEIGHT) IN HEIGHT REQUIRE CERTIFICATION BY A LICENSED PROFESSIONAL ENGINEER IN THE STATE OF NEW JERSEY CONFIRMING THAT THE WALL WAS BUILT IN ACCORDANCE WITH THE PLANS AND DETAILS AND THAT IT WILL SUPPORT ITS DESIGN AND INTENDED LOADS. PROVIDE FALL PROTECTION AS REQUIRED.


CIVIL ENGINEERING CIVIL ENGINEERING CONTROL SURVEYING CONTROL SURV
MARK S. MARTINS Professional Engineer & Land Surveyor New Jersey License No. 35,858 Member Mark Martins Engineering, LLC

GRADING & UTILITIES PLAN


311 EAST EDSALL BLVD LOT 15 & BLOCK 412 Situated in the

Borough of Palisades Park Bergen County, NJ

SCALE: 1" = 20'	DRAWN:SF	CHECK'D:MM	SHEET
DATE: 12-04-20	04-20 FILE NO. 20-2812		4 OF 8

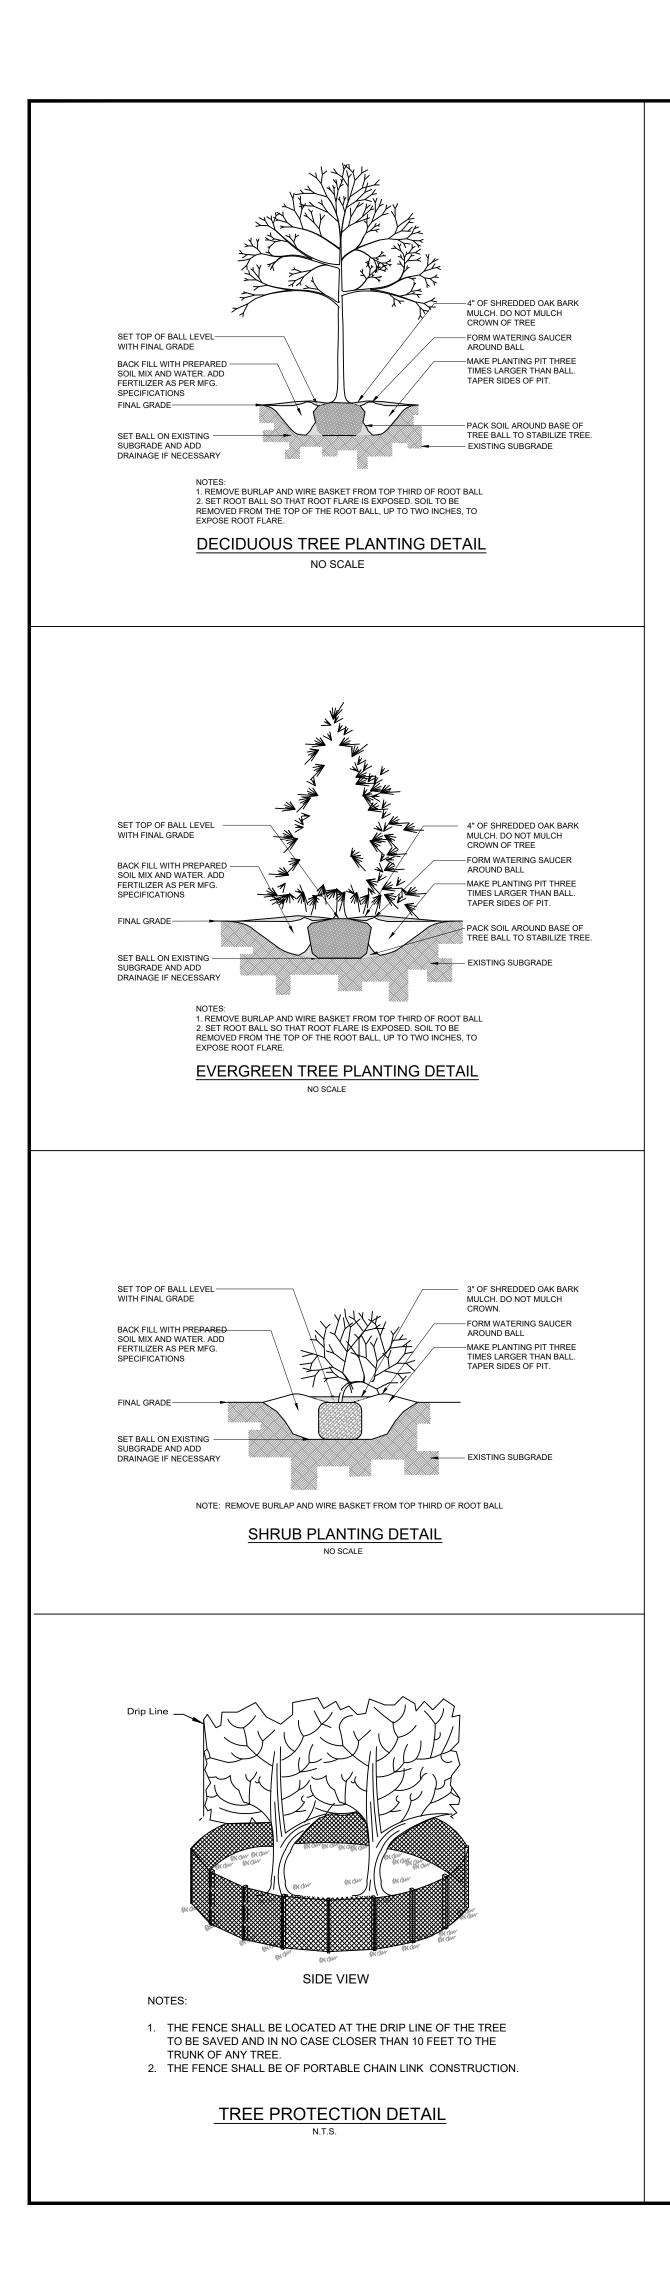

KEYQTY.AR2ACERAZ14AZALEBU18BUXUSCC1CERCICF1CORNIJA138JUNIPIRZ10RHODOTM15TAXUSTO22THUJAZM2ZELKO

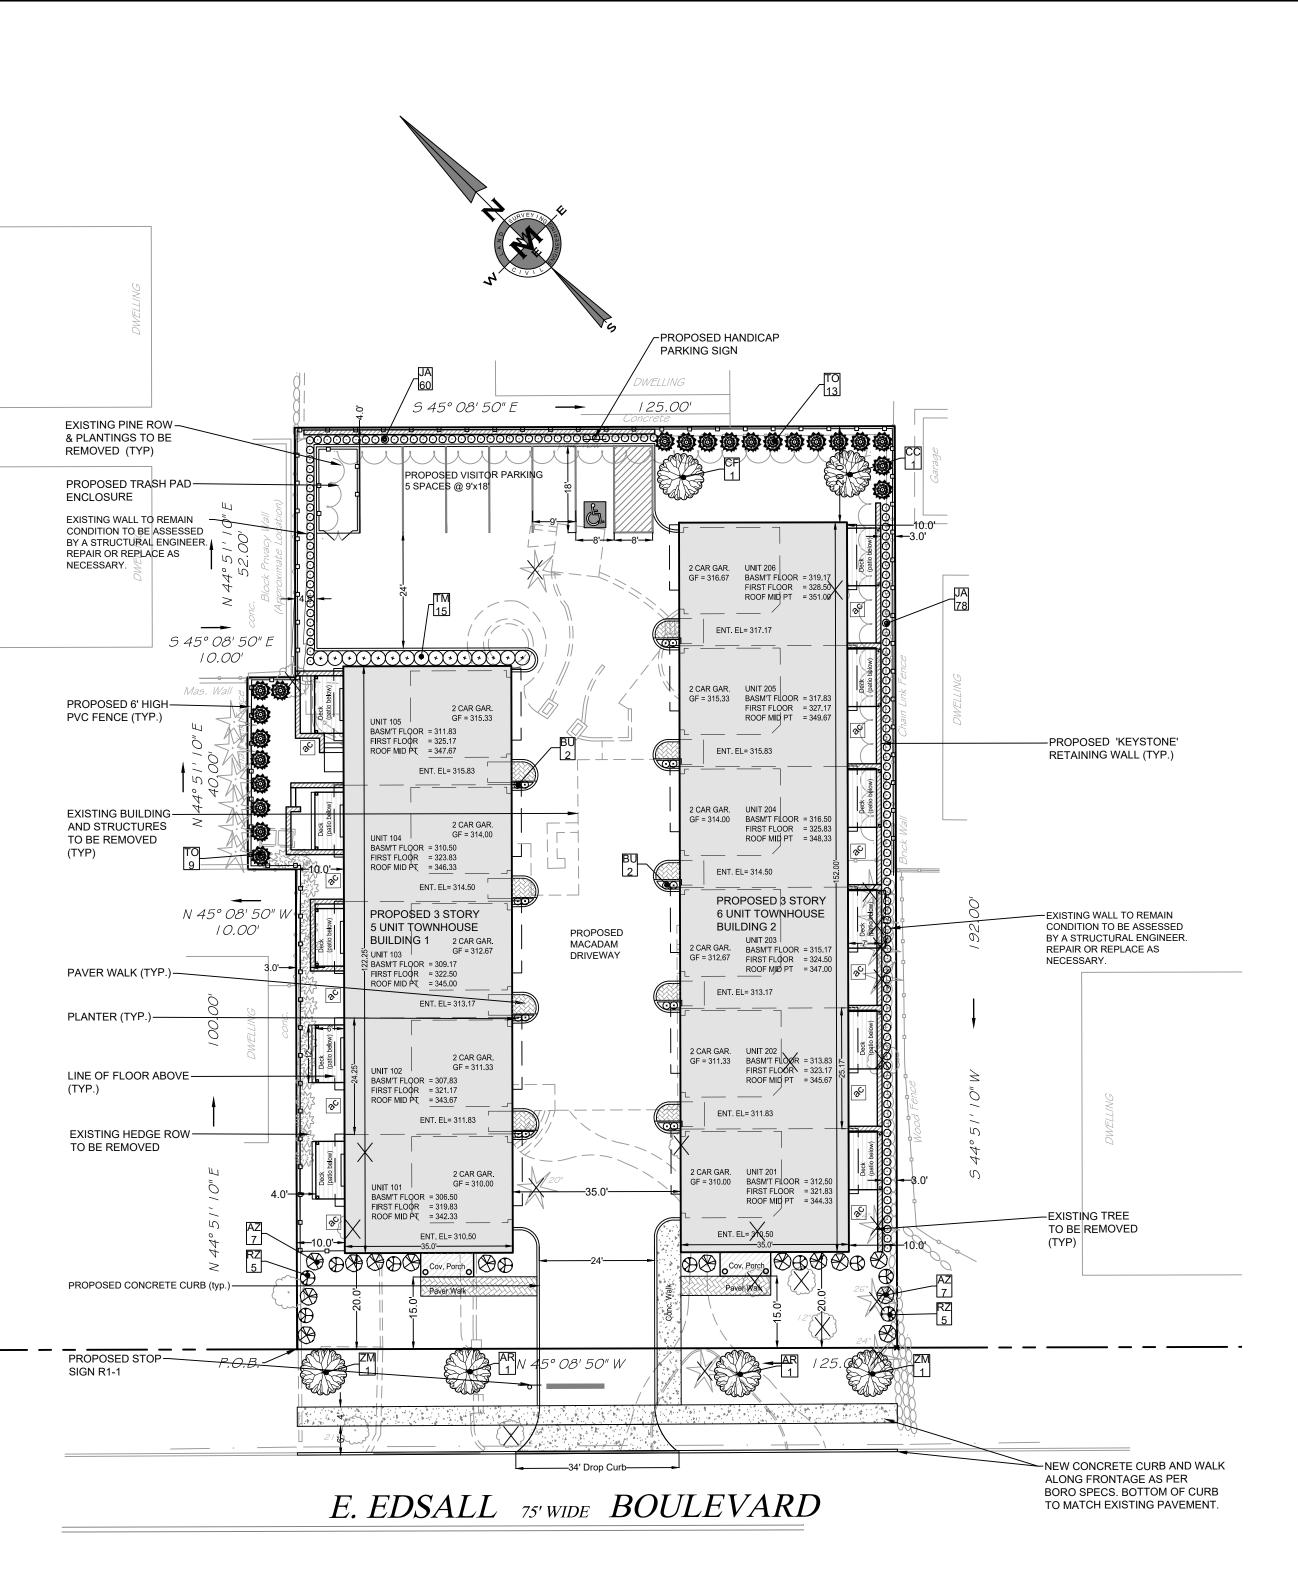

PLANT SCHEDULE						
BOTANICAL NAME	COMMON NAME	ROOT	HEIGHT	REMARKS		
RUBRUM	RED MAPLE	B & B	2" cal.	STRONG SINGLE LEADER, BRANCHED-UP 7'		
EA HYBRID 'MOTHER'S DAY'	MOTHER'S DAY AZALEA	No. 2 can	18"-24"	FULL, DENSE FORM		
IS MICROPHYLLA 'GREEN BEAUTY'	JAPANESE BOXWOOD	No. 2 can	15"-18"	COMPACT HABIT, GLOSSY DARK GREEN FOLIAGE		
CIS CANADENSIS	EASTERN REDBUD	B & B	2" cal.	DENSE BRANCHING, FULL FORM		
NUS FLORIDA	FLOWERING DOGWOOD	B & B	2" cal.	MULTI STEM, FULL, DENSE FORM		
PERUS HORIZONTALIS PLUMOSA	ANDORRA JUNIPER	B & B	15"-18"	FULL DENSE FORM, UNIFORM SIZE & SHAPE		
DODENDRON HYBRID 'NOVA ZEMBLA'	NOVA ZEMBLA RHODODENDRUM	B & B	30"-36"	FULL, DENSE FORM		
IS MEDIA 'MEYERI'	MEYERS YEW	B & B	18"-24"	FULL, DENSE FORM		
A OCCIDENTALIS 'EMERALD GREEN'	EMERALD GREEN ARBOVITAE	B & B	4'-5'	DENSE BRANCHING, UNIFORM SIZE & SHAPE		
OVA SERRATA 'MUSASHINO'	JAPANESE ZELKOVA	B & B	2" cal.	STRAIGHT TRUNK, FULL HEAD		

-		-
NO.	DATE	

LANDSCAPE NOTES:

- 1. EVERY EFFORT TO BE MADE BY THE CONTRACTOR TO PREVENT/MINIMIZE COMPACTION OF SOIL IMMEDIATELY OVER THE TREES ROOT SYSTEM WITHIN THE DRIP
- LINE.
 2. ALL STUMPS AND OTHER TREE PARTS, LITTER, WEEDS, EXCESS OR SCRAP BUILDING MATERIALS, OR OTHER DEBRIS SHALL BE REMOVED FROM THE SITE AND DISPOSED OF IN ACCORDANCE WITH NEW JERSEY DEPARTMENT OF ENVIRONMENTAL PROTECTION REGULATIONS, NO TREE STUMPS, PORTIONS OF TREE TRUNKS OR LIMBS SHALL BE BURIED ANYWHERE IN THE DEVELOPMENT. ALL DEAD OR TYING TREES, STANDING OR FALLEN. SHALL BE REMOVED FROM THE SITE.
- PRIOR TO ANY EXCAVATION FOR THE INSTALLATION OF PLANT MATERIAL, THE CONTRACTOR SHALL DETERMINE THE EXACT LOCATION AND ELEVATION OF ANY AND ALL UNDERGROUND UTILITIES.
- 4. THE CONTRACTOR SHALL INSPECT ALL PLANTING AREAS BEFORE ANY TOPSOILING OR PLANTING IS BEGUN TO ENSURE ADEQUATE DRAINAGE EXISTS. IF ANY AREAS TO BE LANDSCAPED SHOW EVIDENCE OF POOR DRAINAGE, THE CONTRACTOR SHALL NOTIFY THE OWNER IMMEDIATELY FOR CORRECTIVE ACTION. ANY PLANT MATERIAL THAT DIES DUE TO POOR OR INADEQUATE DRAINAGE SHALL BE THE RESPONSIBILITY OF THE LANDSCAPE CONTRACTOR.
- 5. TOPSOIL MOVED DURING THE COURSE OF CONSTRUCTION SHALL BE REDISTRIBUTED SO AS TO PROVIDE AT LEAST SIX (6) INCHES OF COVER TO ALL LANDSCAPED AREAS AND EIGHTEEN (18) INCHES IN ALL PLANT BED AND TREE PIT AREAS OF THE DEVELOPMENT
- AND SHALL BE STABILIZED BY SEEDING, SODDING OR PLANTING.
 6. TOPSOIL SHALL BE A NATURAL, FRIABLE TOPSOIL, REPRESENTATIVE OF PRODUCTIVE SOILS IN THE VICINITY. IT SHALL BE OBTAINED FROM WELL-DRAINED AREAS, FREE OF SUBSOIL, FOREIGN MATTER, TOXIC SUBSTANCES AND ANY HARMFUL MATERIAL.
- 7. BACKFILL MATERIAL FOR BACKFILLING AROUND TREE/SHRUB BALLS SHALL BE A MIXTURE BY VOLUME OF THE FOLLOWING MATERIALS IN QUANTITIES SPECIFIED: 1/5 PEAT MOSS, 4/5 TOPSOIL. ADD 15 LBS. OF 20-10-5 FERTILIZER PER CUBIC YARD OF BACKFILL. BACKFILL MATERIAL
- BY ANALYSIS SHALL HAVE AT LEAST 15% ORGANIC MATTER.
 8. ALL PLANT MATERIAL THAT IS TO BE INSTALLED TO BE IN FULL COMPLIANCE WITH THE SPECIFICATIONS CITED IN THE "PLANT LIST". ANY DEVIATION/SUBSTITUTION FROM THE PLANT LIST TO BE REVIEWED AND APPROVED BY THE PROJECT LANDSCAPE
- ARCHITECT PRIOR TO THE PURCHASE OF THE MATERIAL. 9. ALL LANDSCAPE MATERIALS TO BE OF NURSERY STOCK AND FREE OF INSECTS AND DISEASE.
- 10. ALL TREES, SHRUBS, AND GROUND COVERS TO COMPLY WITH THE REQUIREMENTS OF ANSI Z60.1 "AMERICAN STANDARD FOR NURSERY STOCK" AND AS FURTHER SPECIFIED.
- 11. ALL TREES TO BE STRAIGHT TRUNKED AND LEADER(S) INTACT. 12. IF AFTER REGRADING ROCK IS EXPOSED PLANTINGS SHALL BE
- ADJUSTED ACCORDINGLY.
- 13. MAINTENANCE BEGIN MAINTENANCE IMMEDIATELY AFTER PLANTING. MAINTAIN TREES, SHRUBS, AND OTHER PLANTS UNTIL FINAL ACCEPTANCE, BUT IN NO CASE LESS THAN 30 DAYS AFTER SUBSTANTIAL COMPLETION OF PLANTING.

MAINTAIN TREES, SHRUBS AND OTHER PLANTS BY PRUNING, CULTIVATING, AND WEEDING AS REQUIRED FOR HEALTHY GROWTH, RESTORE PLANTING SAUCERS. TIGHTEN AND REPAIR STAKE AND GUY SUPPORTS AND RESET TREES AND SHRUBS TO PROPER GRADES OR VERTICAL POSITION AS REQUIRED. RESTORE OR REPLACE DAMAGED WRAPPINGS. SPRAY AS REQUIRED TO KEEP TREES AND SHRUBS FREE OF INSECTS AND DISEASE.


MAINTAIN LAWNS FOR NOT LESS THAN THE PERIOD STATED BELOW, AND LONGER AS REQUIRED TO ESTABLISH AND ACCEPTABLE LAWN.

- SEEDED LAWNS, NOT LESS THAN 60 DAYS AFTER SUBSTANTIAL COMPLETION.
 IF SEEDED IN FALL AND NOT GIVE FULL 60 DAYS OF MAINTENANCE, OR IF NOT CONSIDERED ACCEPTABLE AT THAT TIME, CONTINUE MAINTENANCE FOLLOWING SPRING UNTIL ACCEPTABLE LAWN IS
- ESTABLISHED. 3. SODDED LAWNS, NOT LESS THATN 30 DAYS AFTER SUBSTANTIAL COMPLETION.

MAINTAIN LAWNS BY WATERING, FERTILIZING, WEEDING, MOWING, TRIMMING, AND OTHER OPERATIONS SUCH AS ROLLING, REGRADING, AND REPLANTING AS REQUIRED TO ESTABLISH A SMOOTH, ACEPTABLE LAWN, FREE OF ERODED OR BARE AREAS.

- 14.ALL LANDSCAPING IS TO BE INSTALLED IN ACCORDANCE WITH THE APPROVED PLAN.15.AN IRRIGATION SYSTEM SHALL BE PROVIDED FOR THE PROPOSED LANDSCAPING IMPROVEMENTS.
- 16.ALL PLANT MATERIAL SHALL BE GUARANTEED TO BE ALIVE AND IN VIGOROUS GROWING CONDITION FOR A PERIOD OF TWO (2) YEARS AFTER ACCEPTANCE BY THE OWNER.
 17.ALL TREES NOT SERVICED BY AUTOMATIC IRRIGATION SHALL BE PROVIDED WITH 20 GALLON TREE WATERING BAGS, AND SHALL BE FILLED/REFILLED AND MAINTAINED BY THE LANDSCAPE CONTRACTOR FOR THE DURATION OF THE GUARANTEE PERIOD OF THE
- PLANT. 18. UPON COMPLETION OF THE TWO (2) YEAR PLANT GUARANTEE PERIOD, THE LANDSCAPE CONTRACTOR IS RESPONSIBLE FOR REMOVING PLANTING SAUCERS FROM ALL TREES. THIS SHALL BE DONE CONSULTATION WITH THE LANDSCAPE ARCHITECT.
- 19. CUT AND REMOVE BURLAP, ROPE, AND WIRE BASKET FROM THE TOP $\frac{1}{3}$ OF THE ROOT BALL. NYLON ROPE AND/OR NYLON BALLING MATERIAL SHALL NOT BE USED.

	FEET) = 20 ft.		80		
	LA	NDSC	APE PI	LAN	
ENGINEERING SURVEYING MARK MARTINS ENGINEERING, LLC 55 WALNUT ST., SUITE 201 · NORWOOD, NJ · 07648 TEL 201-391-3222 · FAX 201-215-2210 CERTIFICATE OF AUTHORIZATION #24GA28265200 MARK S. MARTINS Professional Engineer & Land Surveyor	311 EAST EDSALL BLVD LOT 15 & BLOCK 412 Situated in the Borough of Palisades Park Bergen County, NJ				
New Jersey License No. 35,858	SCALE: 1" = 20'	DRAWN:SF	CHECK'D:MM	SHEET 5 OF 8	
Member Mark Martins Engineering, LLC	DATE: 12-04-20	FILE NC	0. 20-2812		

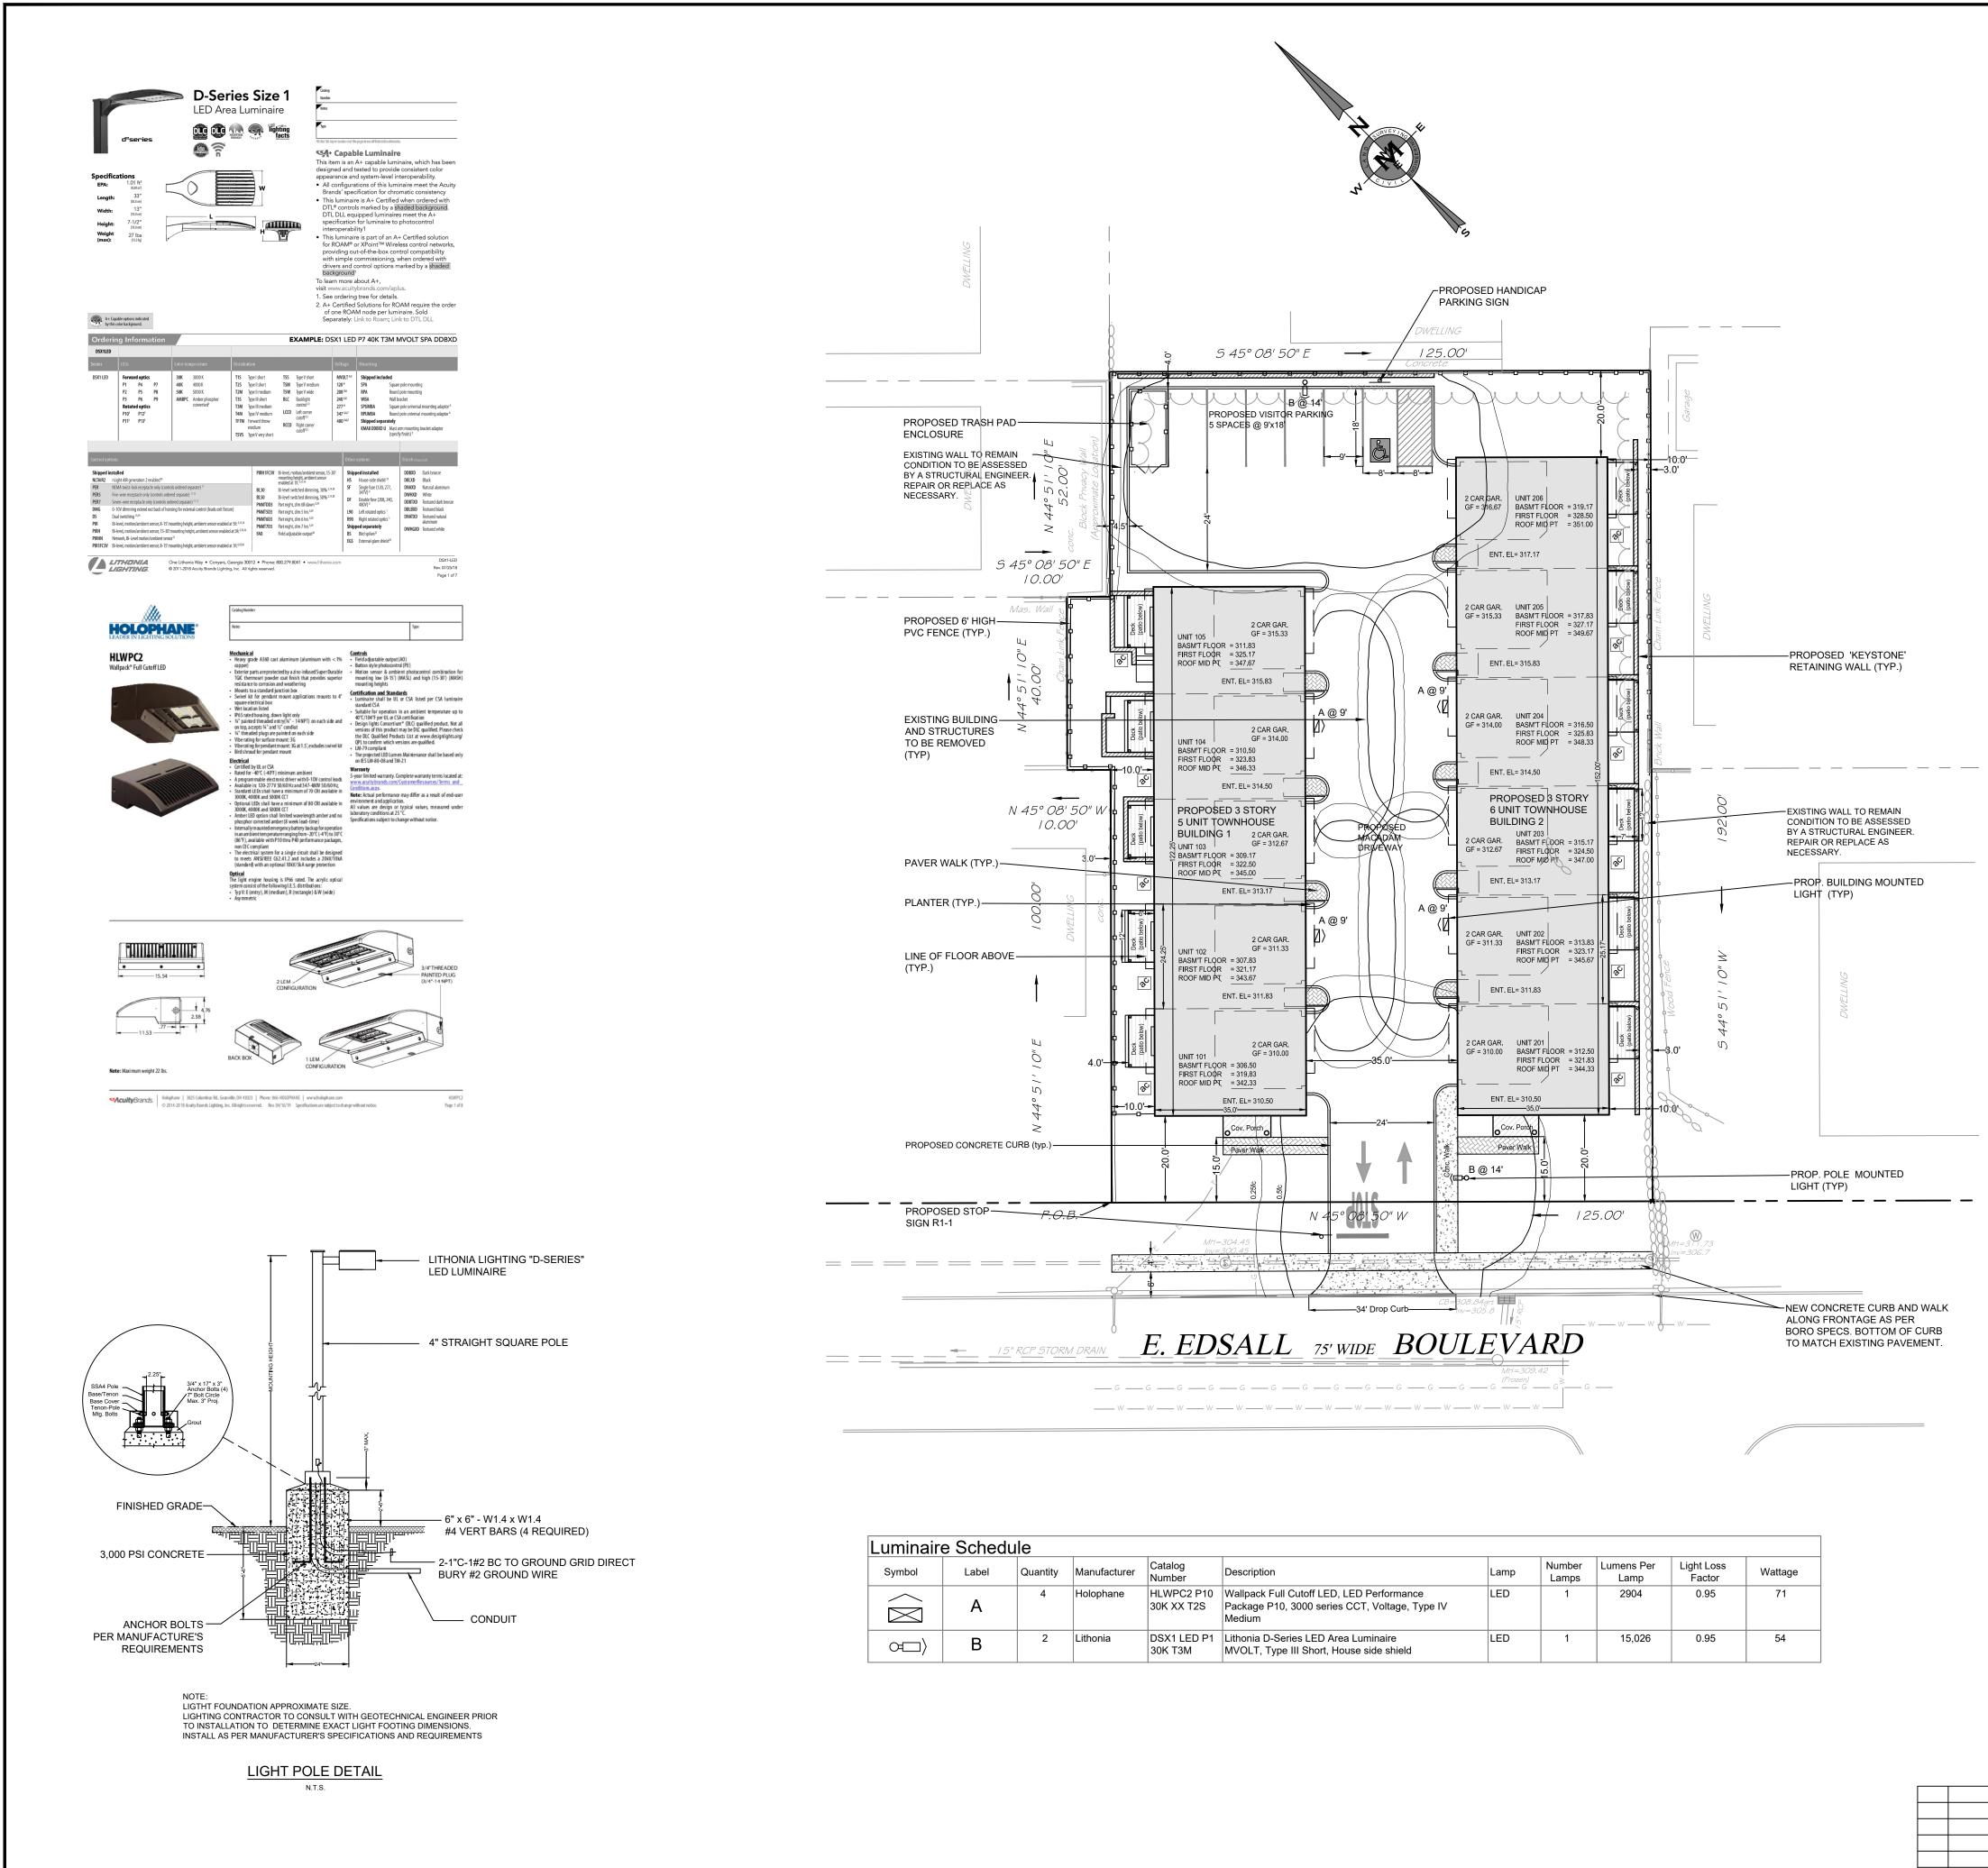


Schedule									
Label	Quantity	Manufacturer	Catalog Number	Description	Lamp	Number Lamps	Lumens Per Lamp	Light Loss Factor	Wattage
А	4	_ ·	30K XX T2S	Wallpack Full Cutoff LED, LED Performance Package P10, 3000 series CCT, Voltage, Type IV Medium	LED	1	2904	0.95	71
В	2	Lithonia		Lithonia D-Series LED Area Luminaire MVOLT, Type III Short, House side shield	LED	1	15,026	0.95	54

NO.	DATE	


LIGHTING NOTES:

- 1. USE THIS WIRING DIAGRAM FOR ESTIMATING PURPOSES ONLY. ELECTRICAL CONTRACTOR IS RESPONSIBLE TO PROVIDE THE EXACT POINT-TO POINT WIRING DIAGRAMS.
- 2. PROVIDE POWER SUPPLIES, LIGHTING CONTROL DEVICES, CONTROL AND WIRING ARE REQUIRED FOR COMPLETE LIGHTING CONTROL.
- 3. PROVIDE AUXILIARY RELAYS, POWER SUPPLIES, CONDUIT AND WIRING AS REQUIRED COMPLETE LIGHTING CONTROL.
- 4. SHIELDING SHALL BE PROVIDED FOR ALL FIXTURES TO PREVENT SPILLAGE ONTO ANY ADJOINING PROPERTIES.

GRAPHIC 20 0 10 20 (IN FI 1 inch =	40 	80			
	LIGHTING PLAN				
ENGINEERING SURVEYING MARK MARTINS ENGINEERING, LLC 55 WALNUT ST., SUITE 201 · NORWOOD, NJ · 07648 TEL 201-391-3222 · FAX 201-215-2210 CERTIFICATE OF AUTHORIZATION #24GA28265200	311 EAST EDSALL BLVD LOT 15 & BLOCK 412 Situated in the				
MARK S. MARTINS Professional Engineer & Land Surveyor New, Jersey License No. 35,858	Borough of Palisades Park Bergen County, NJ				
	SCALE: 1" = 20'	DRAWN:SF CHECK'D:MM	SHEET		
BY Member Mark Martins Engineering, LLC	DATE: 12-04-20	FILE NO. 20-2812	6 OF 8		

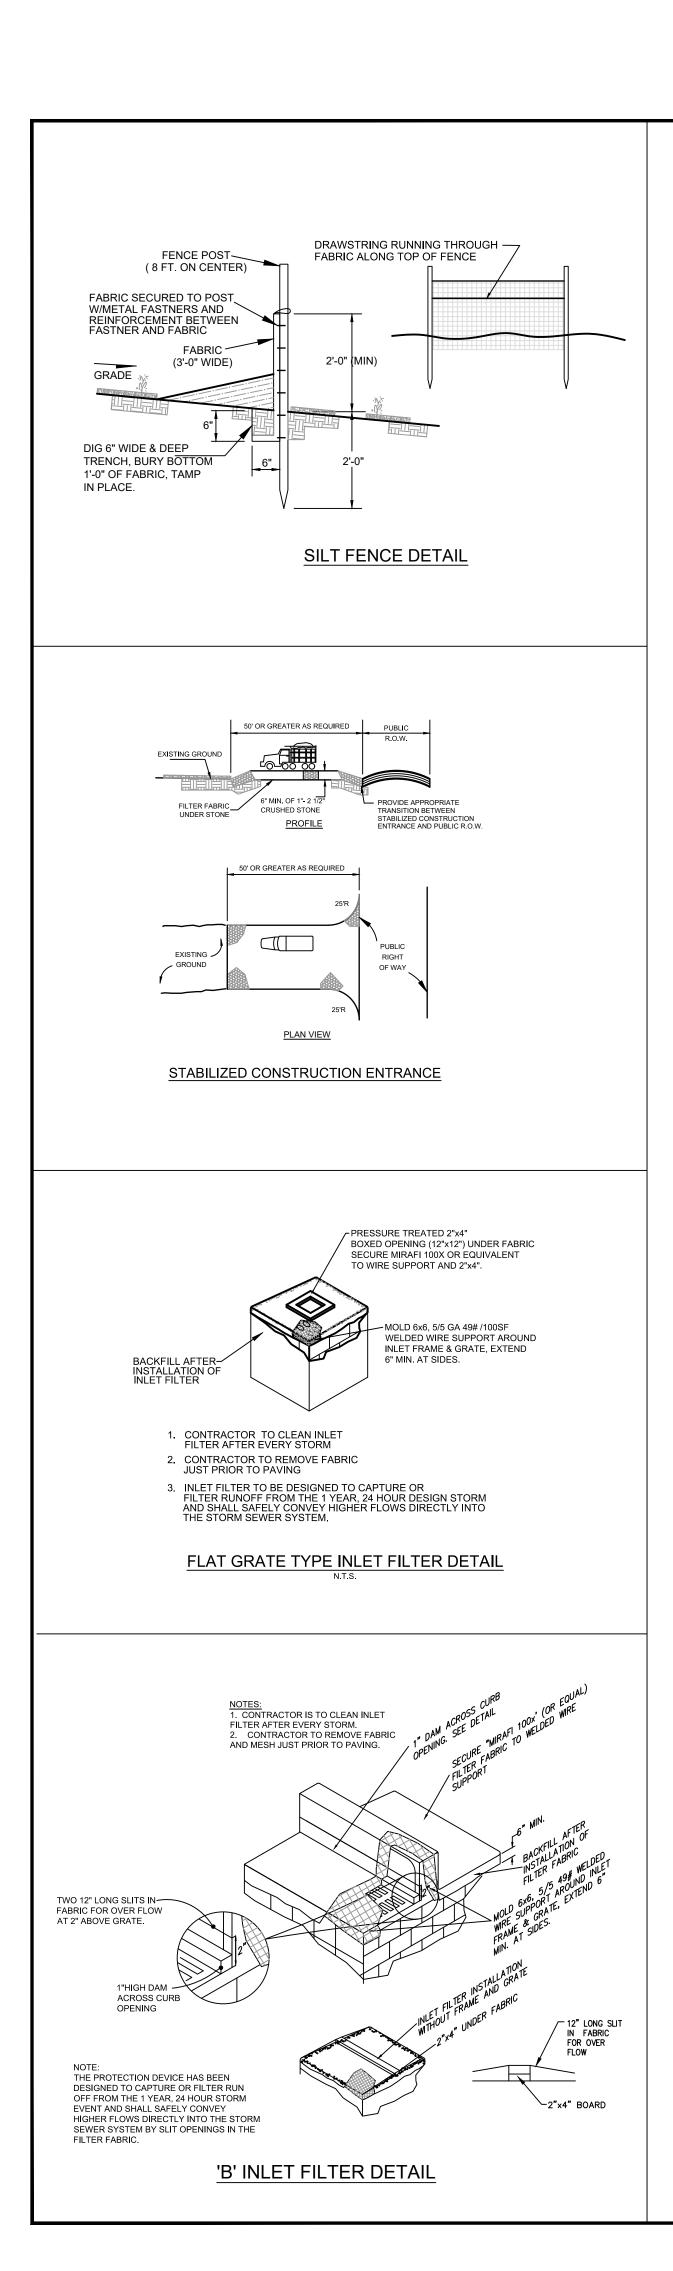

NECESSARY. GRT 313.92 INV 311.42 (TYP) (TYP.) 1.0% (TYP.) TOP 303.67 INV 305.00 SIGN R1-1 RIM 304.33 INV 301.08

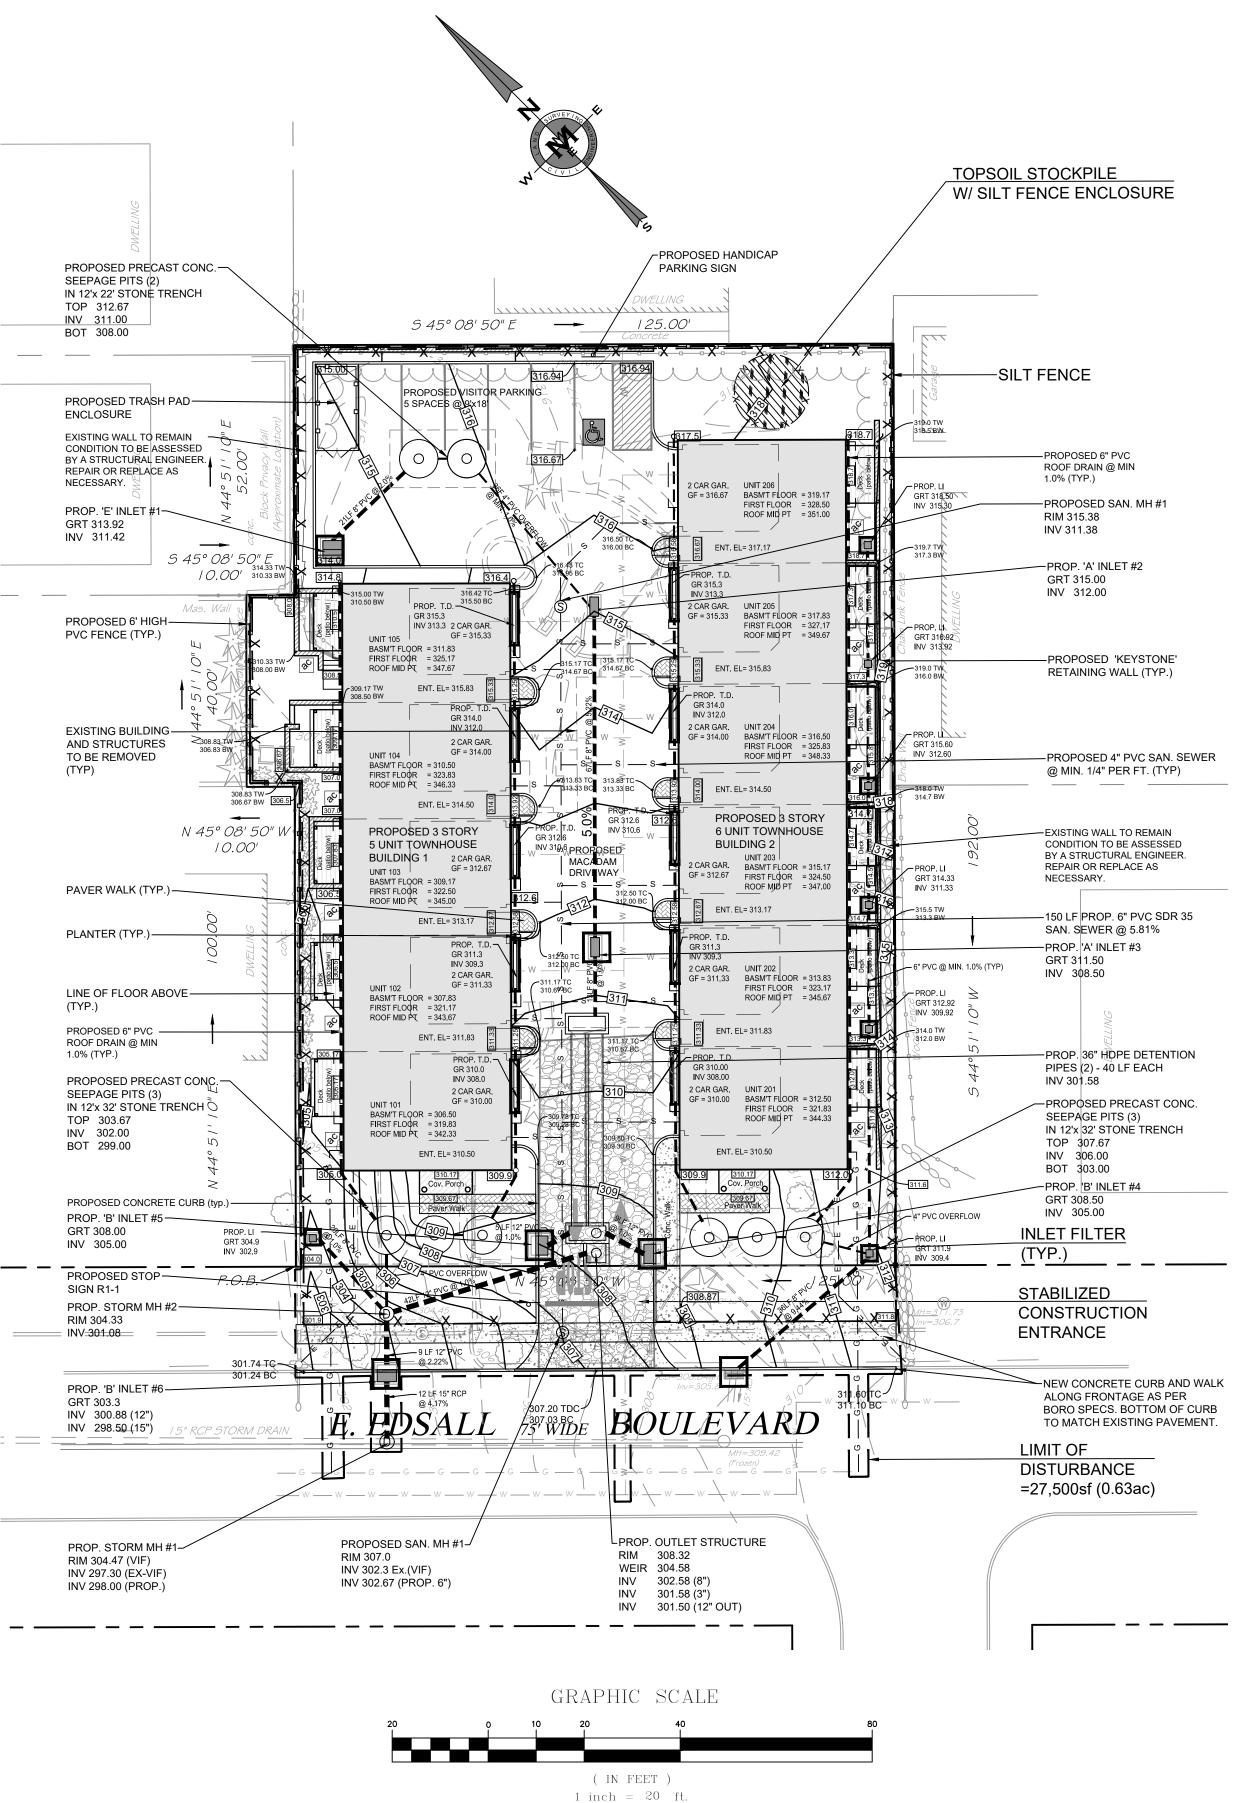

SOIL EROSION AND SEDIMENT CONTROL NOTES

- 1. All soil erosion and sediment control practices will be installed in accordance with the Standards for Soil Erosion and Sediment Control in New Jersey (NJ Standards), and will be installed in proper sequence and maintained until permanent stabilization is established.
- 2. Any disturbed area that will be left exposed for more than thirty (30) days and not subject to construction traffic shall immediately receive a temporary seeding and mulching. If the season prohibits temporary seeding, the disturbed area will be mulched with unrotted straw at a rate of 2 tons per acre anchored by approved methods (i.e. peg and twine, mulch netting, or liquid mulch binder).
- 3. Immediately following initial disturbance or rough grading, all critical areas subject to erosion will receive a temporary seeding in combination with straw mulch or a suitable equivalent, at a rate of 2 tons per acre, according to the NJ Standards.
- 4. Stabilization Specifications: A. Temporary Seeding and Mulching:
- Ground Limestone Applied uniformly according to soil test recommendations. - Fertilizer - Apply 11lbs./1,000 sf of 10-20-10 or equivalent with 50% water insoluble nitrogen (unless a soil test indicates otherwise)worked into the soil a minimum of 4".
- Seed perennial ryegrass 100 lbs./acre (2.3 lbs./1,000 sf) or other approved seed; plant between March 1 and May 15 or between August 15 and October 1. - Mulch - Unrotted straw or hay at a rate of 70 to 90 lbs./1,000 sf applied to achieve 95% soil surface coverage. Mulch shall be anchored by approved methods (i.e. peg and twine, mulch netting, or liquid mulch binder).
- B. Permanent Seeding and Mulching: - Topsoil - Uniform application to an average depth of 5", minimum of 4" firmed in place is required.
- Ground Limestone Applied uniformly according to soil test recommendations. - Fertilizer - Apply 11 lbs./1,000 sf of 10-10-10 or equivalent with 50% water insoluble nitrogen (unless a soil test indicates otherwise) worked into the soil a
- minimum of 4". - Seed - Turf type tall fescue (blend of 3 cultivars) 350 lbs./acre (8 lbs./1,000 sf) or other approved seeds; plant between March 1 and October 1(summer seedings require irrigation)
- Mulch Unrotted straw or hay at a rate of 70 to 90 lbs./1,000 sf applied to achieve 95% soil surface coverage. Mulch shall be anchored by approved methods (i.e. peg and twine, mulch netting, or liquid mulch binder). 5. The site shall at all times be graded and maintained such that all Stormwater
- runoff is diverted to soil erosion and sediment control facilities.
- 6. Soil erosion and sediment control measures will be inspected and maintained on a regular basis, including after every storm event.
- 7. Stockpiles are not to be located within 50' of a floodplain, slope, roadway or drainage facility. The base of all stockpiles shall be contained by a haybale sediment barrier or silt fence.
- 8. A crushed stone, vehicle wheel-cleaning blanket will be installed wherever a construction access road intersects any paved roadway. Said blanket will be composed of $1" - 2\frac{1}{2}"$ crushed stone, 6" thick, will be at least 30' x 100' and should be underlain with a suitable synthetic sediment filter fabric and maintained. 9. Maximum side slopes of all exposed surfaces shall not exceed 3:1 unless otherwise
- approved by the District. 10. Driveways must be stabilized with 1" - 21/2" crushed stone or subbase prior to
- individual lot construction.
- 11. All soil washed, dropped, spilled or tracked outside the limit of disturbance or onto public right-of-ways, will be removed immediately. Paved roadways must be kept clean at all times.
- 12. Catch basin inlets will be protected with an inlet filter designed in accordance with Section 28 -1 of the NJ Standards.
- 13. Storm drainage outlets will be stabilized, as required, before the discharge points become operational.
- 14. Dewatering operations must discharge directly into a sediment control bag or other approved filter in accordance with Section 14-1 of the NJ Standards. 15. Dust shall be controlled via the application of water, calcium chloride or other
- approved method in accordance with Section 16-1 of the NJ Standards. 16. Trees to remain after construction are to be protected with a suitable fence installed
- at the drip line or beyond in accordance with Section 9-1 of the NJ Standards. 17. The project owner shall be responsible for any erosion or sedimentation that may
- occur below stormwater outfalls or off-site as a result of construction of the project. 18. Any revision to the certified Soil Erosion and Sediment Control Plan must be
- submitted to the District for review and approval prior to implementation in the field. 19. A copy of the certified Soil Erosion and Sediment Control Plan must be available at
- the project site throughout construction. 20. The Bergen County Soil Conservation District must be notified, in writing, at least 48 hours prior to any land disturbance: Bergen County SCD, 700 Kinderkamack Road, Suite 106, Oradell, NJ 07649. Tel: 201-261-4407; Fax 201-261-7573.
- 21. The Bergen County Soil Conservation District may request additional measures to minimize on or off-site erosion problems during construction.
- 22. The owner must obtain a District issued report of compliance prior to the issuance of any certificate of occupancy. The District requires at least one week's notice to facilitate the scheduling of all report of compliance inspections. All site work must be completed, including temporary/permanent stabilization of all exposed areas, prior to the issuance of a report of compliance by the District.
 - -----Revised 12/7/17

SOIL EROSION CONSTRUCTION SEQUENCE:

- 1. Demolish existing building and structures.
- Remove existing pavement and curbs 1st week.
- 2. Install construction entrance, silt fences, strip topsoil 1st 3rd day
- 3. Construct proposed storm drainage system. install inlet filters 2nd week 4. Excavate and rough grade site. temporary seed/mulch disturbed areas 3rd - 4 th week.
- 5. Construct proposed building 4th week 52nd week
- 6. Backfill foundation 6th week.
- 7. Construct proposed curbing 48th week. 8. Pave parking areas and driveways - 50th week.
- 9. Final grading, uniformly apply topsoil to an average depth of 5", minimum of 4", firmed in place - 51st week.
- 10. Planting, seeding, removal of soil erosion protection measures upon permitted stabilization of previously exposed areas - 52nd week.

NOTE: THIS PROJECT IS EXEMPT FROM SOIL COMPACTION TESTING AND REMEDIATION AS IT IS LOCATED IN AN URBAN REDEVELOPMENT AREA

		SOIL EROSION CONTROL PLAN					
	MARK MARTINS ENGINEERING, LLC 55 WALNUT ST., SUITE 201 · NORWOOD, NJ · 07648 TEL 201-391-3222 · FAX 201-215-2210 CERTIFICATE OF AUTHORIZATION #24GA28265200	311 EAST EDSALL BLVD LOT 15 & BLOCK 412 Situated in the					
	MARK S. MARTINS Professional Engineer & Land Surveyor New Jersey License No. 35,858	Borough of Palisades Park Bergen County, NJ					
_		SCALE: 1" = 20'	DRAWN:SF	CHECK'D:MM	SHEET		
	Member Mark Martins Engineering, LLC	DATE: 12-04-20	FILE NO	7 OF 8			

